


# Attachment 1 to Item 2.1.2

### Plans of Proposal

Date of meeting: 16 February 2023

Location: By audio-visual link

Time: 10:00 a.m.

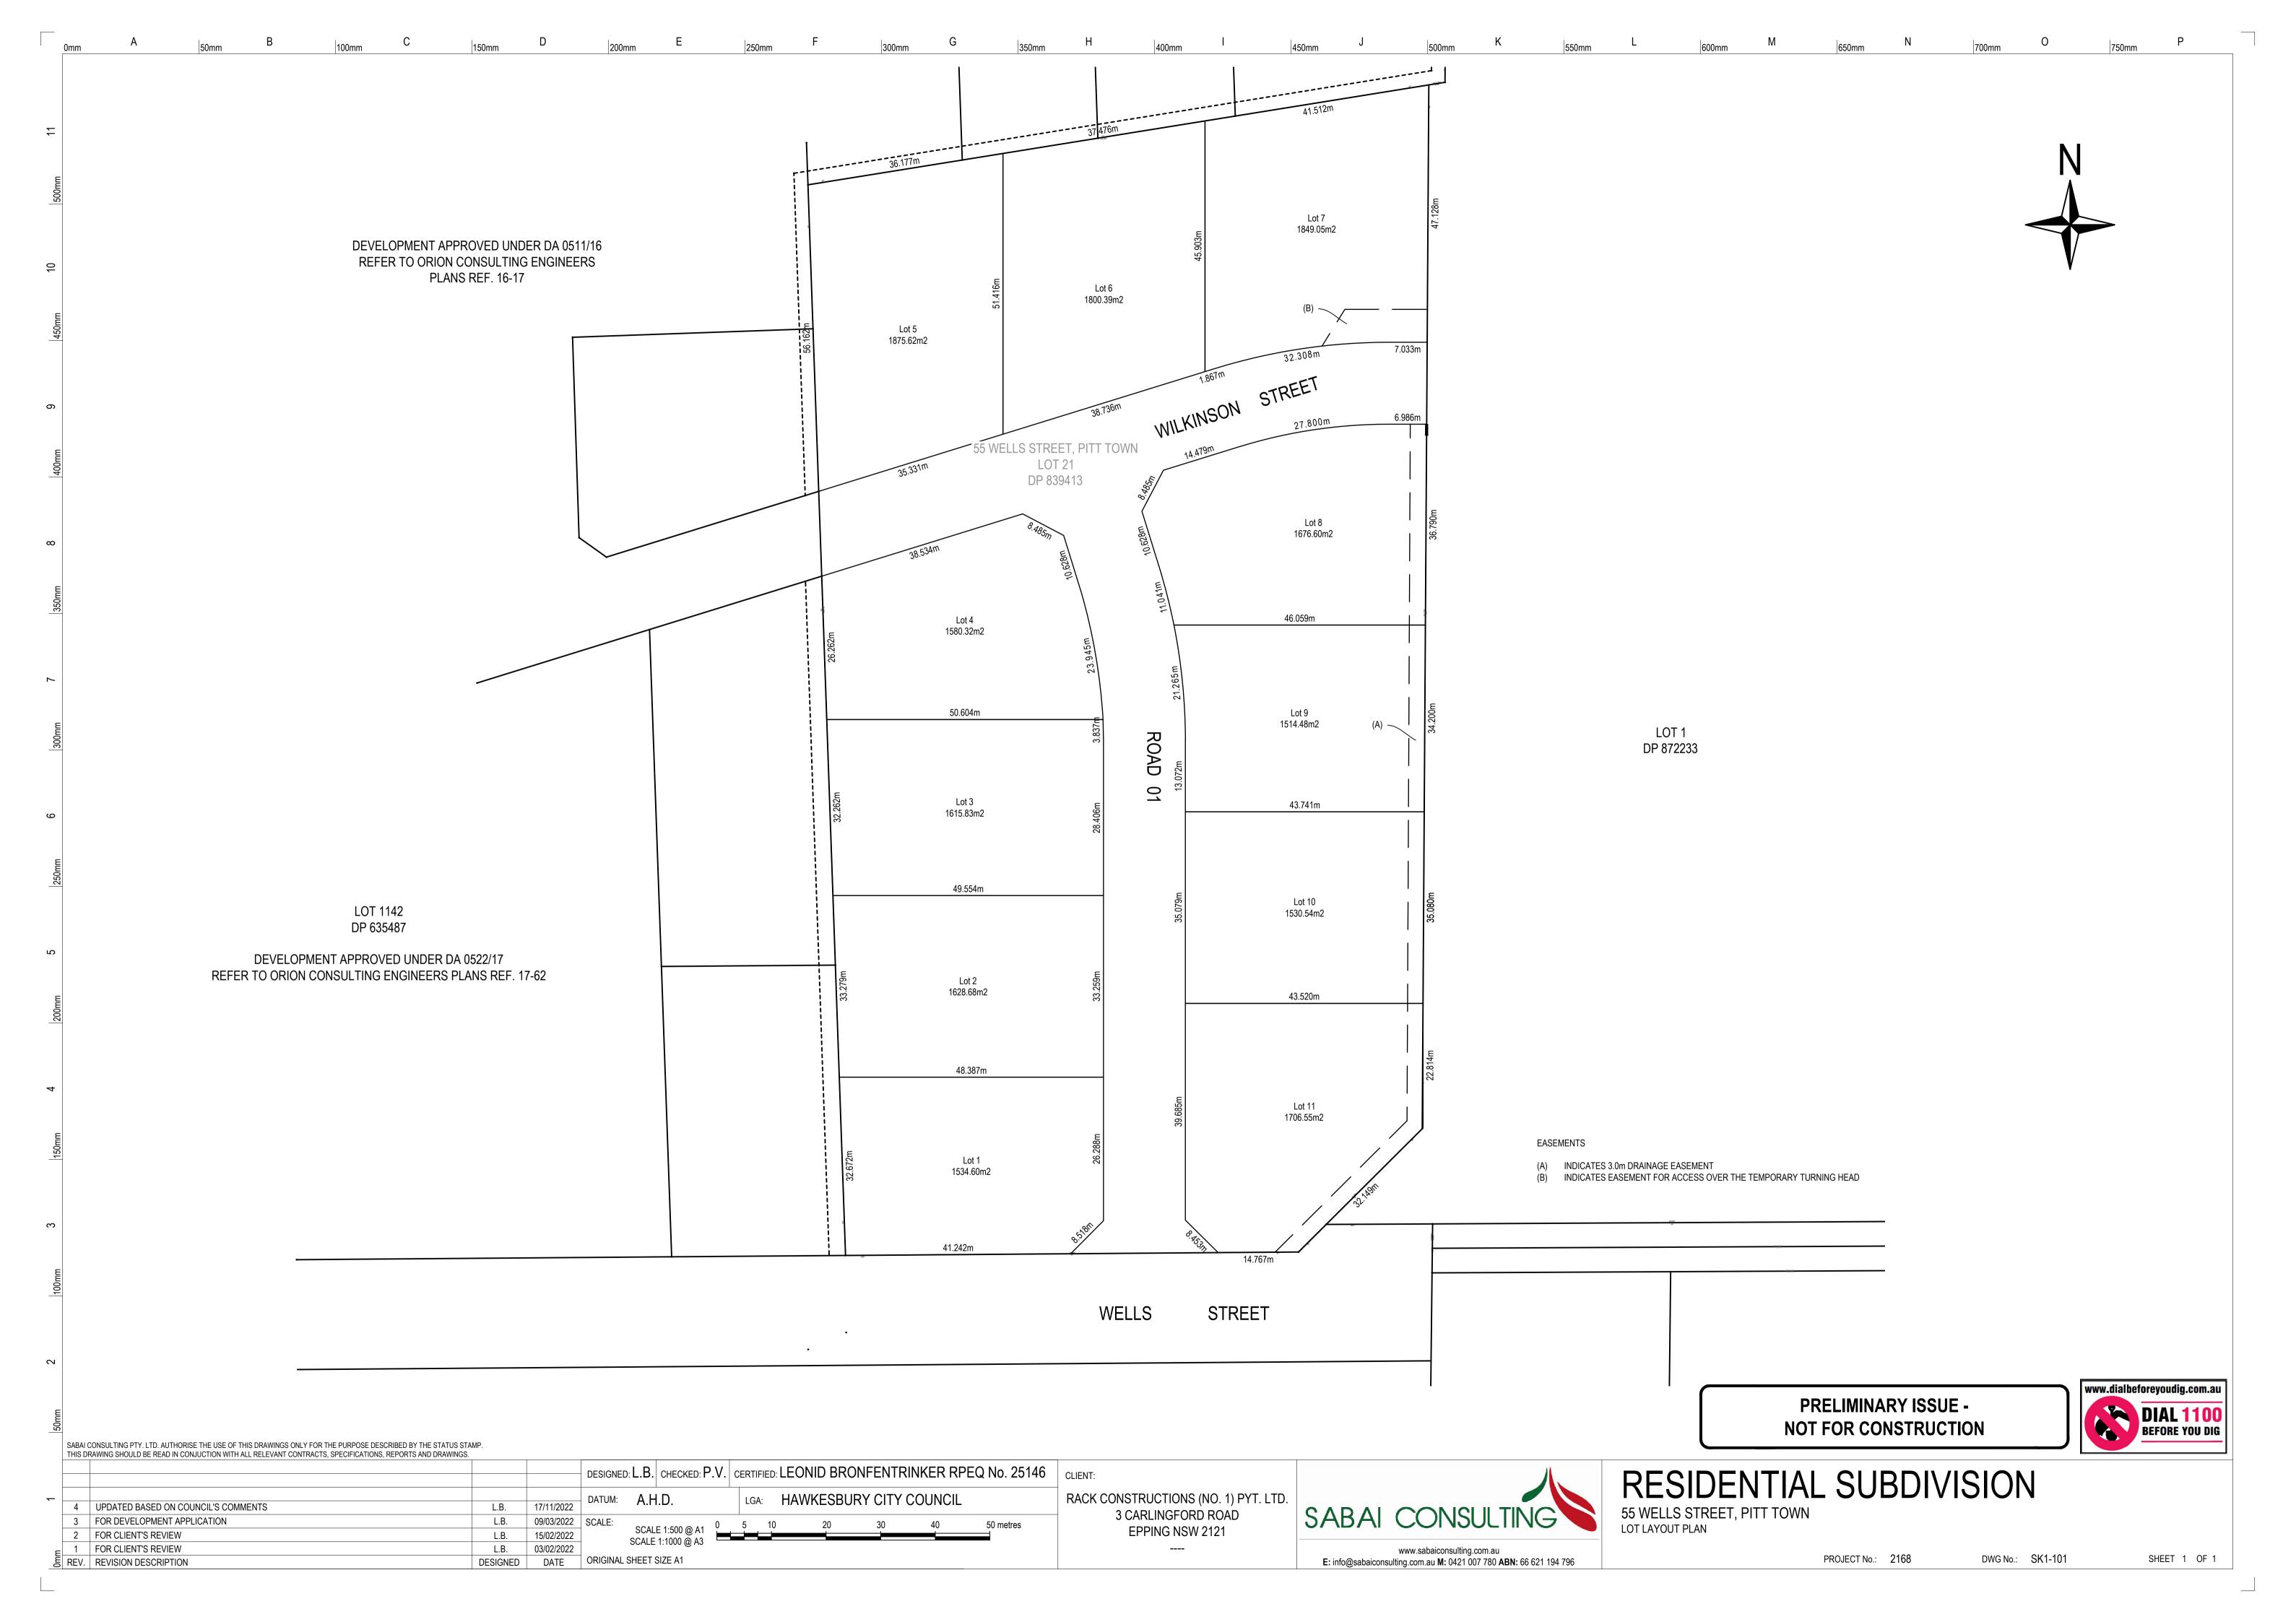

\* CIVIL ENGINEERING PLANS



PROJECT: RESIDENTIAL SUBDIVISION

ADDRESS: 55 WELLS STREET, PITT TOWN

STAGE: DEVELOPMENT APPLICATION



DRAWING INDEX					
SHEET NUMBER	SHEET TITLE				
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CD1-110	DEMOLITION, TREE REMOVAL AND EROSION AND SEDIMENT CONTROL PLAN				
CD1-120	BULK EARTHWORKS PLAN				
CD1-121	SITE SECTIONS - SHEET 1				
CD1-122	SITE SECTIONS - SHEET 2				
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CD1-161	RETAINING WALL LONGITUDINAL SECTIONS				
CD1-170	LINEMARKING AND SIGNAGE PLAN				

PRELIMINARY ISSUE - NOT FOR CONSTRUCTION



LOCALITY PLAN
SCALE: 1:5000

DESIGNED: L.B. CHECKED: P.V. CERTIFIED: LEONID BRONFENTRINKER RPEQ No. 25146

UPDATED BASED ON COUNCIL'S COMMENTS	L.B. 17/11/2022
3 FOR DEVELOPMENT APPLICATION	L.B. 09/03/2022
2 DRAFT DA PLANS FOR CLIENT'S REVIEW	L.B. 01/03/2022
1 FOR CLIENT'S REVIEW	L.B. 02/12/2021
REV. REVISION DESCRIPTION	DESIGNED

SABAI CONSULTING PTY. LTD. AUTHORISE THE USE OF THIS DRAWINGS ONLY FOR THE PURPOSE DESCRIBED BY THE STATUS STAMP.

RACK CONSTRUCTIONS (NO. 1) PTY. LTD.

3 CARLINGFORD ROAD

EPPING NSW 2121





COVER SHEET AND LOCALITY PLAN

PROJECT No.: 2168 DWG No.: CD1-100

SHEET 1 OF 13

#### 25. STORM WATER LINES LAID ACROSS THE COUNCIL NATURE STRIP SHALL BE 100mm SEWER GRADE PVC AND ACHIEVE 300mm COVER WHERE POSSIBLE. GENERAL CIVIL LEGEND 26. GUTTERS ASSUMED TO BE QUAD LOW-FRONT STYLE WITH AN EFFECTIVE CROSS-SECTIONAL AREA (Ae) OF 8611 mm<sup>2</sup> 1. ALL WORKS TO BE CARRIED OUT IN ACCORDANCE WITH COUNCIL'S SPECIFICATIONS AND TO THE REQUIREMENTS OF COUNCIL'S ENGINEER. 27. GUTTERS TO BE INSTALLED AT MIN. SLOPE OF 1:500. 2. TECHNICAL SPECIFICATIONS OR SPECIFIC INSTRUCTIONS ON DRAWINGS TAKE PRECEDENCE OVER THESE NOTES. SITE BOUNDARY 3. DO NOT DEPART FROM THE DESIGN UNLESS AUTHORISED IN WRITING BY THE DESIGN ENGINEER. EARTHWORKS 4. ALL DIMENSIONS AND LEVELS SHOWN ON THE DRAWINGS SHALL BE VERIFIED BY THE CONTRACTOR ON SITE. CIVIL DRAWINGS SHALL NOT BE SCALED FOR DIMENSIONS. THE ENGINEER SHALL BE NOTIFIED OF ANY DISCREPANCIES PRIOR TO CONSTRUCTION. PROVIDE 150mm TOPSOIL WITH TURF OR GRASS SEEDING ON ALL FOOTPATHS AND FILLED AREAS. ROAD CENTRELINE 2. COUNCIL'S TREE PRESERVATION ORDER IS TO BE STRICTLY ADHERED TO. 2. MAKE SMOOTH JUNCTIONS WITH EXISTING WORKS. 3. IF THERE IS DOUBT REGARDING THE CIVIL DESIGN, CONTACT THE ENGINEER FOR CLARIFICATION. 3. GUIDE POSTS WITH ATTACHED REFLECTORS TO BE PLACED WHERE DIRECTED. KERB AND GUTTER (REFER TO SCC STANDARD DRAWING 2637-09) 4. THE SURVEY INFORMATION IS SHOWN TO PROVIDE A BASIS FOR DESIGN. SABAI CONSULTING PTY. LTD. DOES NOT GUARANTEE THE ACCURACY OR 4. PROVISION TO BE MADE FOR SUITABLE PROTECTION OF ROAD PAVEMENT KERB AND GUTTER AND FOOTPATH FORMATION. COMPLETENESS OF THE SURVEY BASE OR ITS SUITABILITY AS A BASIS FOR CONSTRUCTION DRAWINGS. 5. WHERE LOT FILLING OF IN EXCESS OF 300mm IS PROPOSED, LEVELS ARE TO BE TAKEN ON THE STRIPPED SURFACE PRIOR TO THE COMMENCEMENT 5. SHOULD DISCREPANCIES BE ENCOUNTERED DURING CONSTRUCTION WITH WHAT IS SHOWN ON THESE PLANS, CONTACT SABAI CONSULTING. OF FILLING AND ON THE FINISHED SURFACE, SUCH LEVELS BEING SHOWN ON THE WORK-AS-EXECUTED PLAN. KERB RAMP (REFER TO SCC STANDARD DRAWING 2637-23) THE CONTRACTOR SHALL ARRANGE ALL SURVEY SETOUT TO BE CARRIED OUT BY A REGISTERED SURVEYOR. 6. SUB-GRADE IN ROCK TO BE RIPPED, SCARIFIED, SPREAD AND COMPACTED TO A MINIMUM DEPTH OF 300mm BELOW THE FINISHED SUB-GRADE LEVEL. 7. BENCH MARK, SURVEY PEGS, LEVEL PEGS OR SUPPLEMENTARY REFERENCE MARKS SHALL NOT BE ADJUSTED OR MOVED WITHOUT WRITTEN 7. NO TOPSOIL TO BE REMOVED FROM THE SITE.

9. WHERE THE SLOPE OF THE NATURAL SURFACE EXCEEDS ONE IN FOUR (1:4) FILL EMBANKMENT, BENCHES ARE TO BE CUT TO PREVENT SLIPPING OF

SERVICES LEGEND

**EXISTING SERVICES** 

PROPOSED SERVICES

EXISTING SEWER GRAVITY MAIN

EXISTING OPTUS CABLE

EXISTING STORMWATER

EXISTING WATER MAIN

EXISTING RECYCLED WATER MAIN

EXISTING ELECTRICITY

EXISTING TELSTRA CABLE

**EXISTING GAS MAIN** 

EXISTING LIGHT POLE

PROPOSED WATER MAIN

PROPOSED HYDRANT

PROPOSED STOP VALVE

PROPOSED SEWER GRAVITY MAIN

PROPOSED SEWER MANHOLE

PROPOSED SEWER RISING MAIN

SERVICE TO BE ABANDONED

10. DETAILS OF THE SOIL TEST AND PAVEMENT DESIGN ARE TO BE SUBMITTED TO COUNCIL PRIOR TO INSPECTION OF SUBGRADE.

8. PUBLIC UTILITY STUB-MAINS TO BE INSTALLED PRIOR TO THE PREPARATION OF SUB-GRADE.

11. ALL FILL TESTING TO BE CONTROLLED AND CERTIFIED BY AN N.A.T.A. REGISTERED LAB.

\_\_\_\_ W \_\_\_\_ W \_\_\_\_

---- RWM ------ RWM ----

\_\_\_ T \_\_\_ T \_\_\_

 $\bowtie$ 

---- RWM ------ RWM ----

-X-X-X-X-

THE FILL MATERIAL AS REQUIRED BY COUNCIL'S ENGINEER.



PRELIMINARY ISSUE - NOT FOR CONSTRUCTION



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APPROVAL FROM THE SUPERINTENDENT. THE CONTRACTOR SHALL TRANSFER ANY PEGS AFFECTED BY THE PROPOSED WORKS TO SIDE POSITIONS

MONDAYS TO FRIDAYS INCLUSIVE AND 8.00am TO 1.00pm ON SATURDAYS. NO WORK SHALL BE UNDERTAKEN OUTSIDE THE HOURS SPECIFIED ABOVE

8. A CONTRACTOR CARRYING OUT WORKS ON A SUBDIVISION SHALL RESTRICT SUCH ACTIVITIES TO WITHIN THE HOURS OF 7.00am TO 6.00pm ON

10. PRIOR TO THE COMMENCEMENT OF CONSTRUCTION WORKS ON ADJOINING PROPERTIES WRITTEN PERMISSION IS TO BE OBTAINED FROM THE

14. DRIVEWAYS / LAYBACKS TO HAVE MINIMUM 1.0m CLEARANCE FROM POWER, LIGHT POLES AND PITS, AND 6.0m CLEARANCE FROM KERB RETURN T.Ps.

1. THE CONTRACTOR MUST CONFIRM THE EXACT LOCATION AND EXTENT OF EXISTING SERVICES PRIOR TO CONSTRUCTION AND NOTIFY ANY

3. IT IS THE RESPONSIBILITY OF THE CONTRACTOR TO COMPLETE A 'DIAL BEFORE YOU DIG' SEARCH AND TO ESTABLISH THE LOCATION AND LEVEL OF

5. IF EXISTING SERVICE UTILITY COVERS AND GRATES OR SURROUNDING SURFACE LEVELS ARE TO BE LOWERED, THE CONTRACTOR IS TO MAKE

PIPES 375 DIA. AND LARGER TO BE REINFORCED CONCRETE PIPES (RCP) CLASS '2' APPROVED SPIGOT AND SOCKET WITH RUBBER RING JOINTS U.N.O.

7. PROVIDE AGRICULTURAL DRAINS WITH FLUSHING POINTS AND STANDARD COVERS AT MAX. 60m INTERVALS AND ELSEWHERE AS DIRECTED BY

8. BEDDING TYPE SHALL BE TYPE HS2 FOR RCP, AND TYPE H2 FOR uPVC. WHERE NECESSARY THE OVERLAY ZONE SHALL BE REDUCED TO

9. WHERE TRENCHES ARE IN ROCK THE PIPE SHALL BE BEDDED ON A MINIMUM OF 50mm CONCRETE BED (OR 75mm BED OF 12mm BLUE METAL) UNDER

13. CONSTRUCT TAIL OUT DRAINS FROM KERB AND GUTTER, WRITTEN PERMISSION TO DISCHARGE WATER BEING OBTAINED FROM ADJOINING OWNER

16. CONDUIT TRENCHES, SUBSOIL DRAINS AND STORMWATER DRAINAGE LINES TO BE BACKFILLED WITH APPROVED WASHED RIVER SAND, FLOODED AND

VIBRATED. CONDUIT TRENCH TO BE GRADED AT MINIMUM OF ONE PERCENT (1%) GRADE TO EITHER SUBSOIL OR STORMWATER DRAINAGE LINES.

18. A SIGN MUST BE AFFIXED TO RAINWATER TANKS CLEARLY STATING THAT THE WATER IN THE TANK IS RAINWATER. TAPS AND PIPES FROM THE TANK

20. TRENCHES SHALL BE LOCATED AWAY FROM THE FOUNDATIONS OF BUILDINGS. STORMWATER LINES TO HAVE A MINIMUM OF 300mm GROUND COVER.

23. WHERE PIPES ARE LOCATED UNDER PAVEMENTS, TRENCHES ARE TO BE BACKFILLED WITH DGB20 COMPACTED IN 150mm LAYERS TO A MINIMUM DRY

24. CARE MUST BE TAKEN WHEN BREAKING INTO COUNCIL KERBS, GUTTERS AND FOOTPATHS AND IT IS THE RESPONSIBILITY OF THE CONTRACTOR TO

22. THE DRAWINGS DEPICT THE INSTALLATION DIAGRAMMATICALLY AND ARE NOT TO BE SCALED. SET OUT ALL WORK TO SUIT ON SITE DIMENSIONS.

CLEARANCES SHALL BE OBTAINED FROM THE RELEVANT SERVICE AUTHORITY. SEARCH RESULTS ARE TO BE KEPT ON SITE AT ALL TIMES.

1. ALL STORMWATER WORKS ARE TO BE UNDERTAKEN BY A LICENSED PLUMBER IN ACCORDANCE WITH COUNCIL'S STANDARDS AND AS 3500.

EXISTING STORMWATER PIPE LOCATIONS AND INVERT LEVELS TO BE CONFIRMED PRIOR TO COMMENCEMENT OF CONSTRUCTION.

10. ALL LONGITUDINAL PIPELINES IN ROADS TO BE LOCATED UNDER KERB AND GUTTER TO BE BACKFILLED WITH WASHED RIVER SAND.

ALL EXISTING SERVICES PRIOR TO THE COMMENCEMENT OF ANY WORK. ANY DISCREPANCIES SHALL BE REPORTED TO THE SUPERINTENDENT.

2. EXISTING SERVICES HAVE BEEN PLOTTED FROM SERVICES SEARCH PLANS AND AS SUCH THEIR ACCURACY CANNOT BE GUARANTEED.

9. VEHICULAR ACCESS AND ALL SERVICES TO BE MAINTAINED AT ALL TIMES TO ADJOINING PROPERTIES AFFECTED BY CONSTRUCTION WORKS.

CLEAR OF OPERATIONS AND SHALL NOTE THE EXTENT OF THE MOVEMENT IN DISTANCE AND LEVEL.

OR ON SUNDAYS WITHOUT THE WRITTEN APPROVAL OF COUNCIL.

CONFLICTS WITH THE DRAWINGS IMMEDIATELY TO THE SUPERINTENDENT.

CERTAIN THAT MINIMUM COVERS TO SERVICES ARE MAINTAINED.

4. PRE-CAST KERB INLETS TO BE USED ON GULLY PITS.

ACCOMMODATE PAVEMENT REQUIREMENTS.

THE BARREL OF THE PIPE.

DENSITY OF 98% U.N.O.

4. CONDUITS TO BE LAID AS DIRECTED BY THE RELEVANT AUTHORITY, CLEAR OF VEHICULAR CROSSINGS.

ADEQUATE PROVISION TO BE MADE FOR SCOURING AND SEDIMENTATION TO ALL DRAINAGE WORKS AS DIRECTED.

PIPES UP TO 300 DIA. SHALL BE SEWER GRADE uPVC WITH SOLVENT WELDED JOINTS.

11. ALL PITS TO BE BENCHED AND STREAMLINED. PROVIDE STEP IRONS FOR ALL PITS OVER 1.2m DEEP.

PROVIDE INDEMNITY FOR GUTTER DISCHARGE ONTO ADJOINING PROPERTY WHERE NECESSARY

19. ALL DOWNPIPES DRAINING TO THE RAINWATER TANK ARE TO BE FITTED WITH FIRST FLUSH DIVERTERS.

ENSURE THESE AREAS ARE REINSTATED TO THE SATISFACTION OF COUNCIL ON COMPLETION OF THE WORKS.

21. ALL STORMWATER PIPES TO BE MINIMUM Ø100 AT MINIMUM 1% GRADE U.N.O ON THE DRAWING.

12. SUITABLE EASEMENTS TO DRAIN WATER TO BE PROVIDED OVER DRAINAGE LINES THROUGH ALLOTMENTS.

COUNCILS ENGINEER. MARK FACE OF KERB ADJACENT TO COVERS "SS".

AND SUBMITTED TO COUNCIL PRIOR TO COMMENCEMENT OF WORKS.

15. LENGTH OF LINTEL SHOWN INDICATES LENGTH OF CLEAR OPENING.

17. 100 YEAR FLOW PATHS TO BE FORMED AT THE TIME OF CONSTRUCTION.

ARE TO BE CLEARLY LABELED INDICATING THAT THE WATER IS RAINWATER.

RELEVANT OWNERS AND SUBMITTED TO COUNCIL.

**SERVICES** 

DRAINAGE

	THIS D	RAWING SHOULD BE READ IN CONJUCTION WITH ALL RELEVANT CONTRACTS, SPECIFICATIONS, REPORTS AND DRAWIN	GS.					
					DESIGNED: L.B.	CHECKED: P.V.	CERTIFIE	ELEONID BRONFENTRINKER RPEQ No. 25146
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	4	UPDATED BASED ON COUNCIL'S COMMENTS	L.B.	17/11/2022	DATONI. A.I	I.D.	LGA.	HAWKESDOKT CITT COUNCIL
	3	FOR DEVELOPMENT APPLICATION	L.B.	09/03/2022	SCALE:			
	2	DRAFT DA PLANS FOR CLIENT'S REVIEW	L.B.	01/03/2022				
	<sub>E</sub> 1	FOR CLIENT'S REVIEW	L.B.	02/12/2021				
	REV.	REVISION DESCRIPTION	DESIGNED	DATE	ORIGINAL SHEET	SIZE A1		

RACK CONSTRUCTIONS (NO. 1) PTY. LTD.

3 CARLINGFORD ROAD

EPPING NSW 2121







55 WELLS STREET, PITT TOWN GENERAL NOTES AND LEGEND

PROJECT No.: 2168

DWG No.: CD1-101 SHE

SHEET 2 OF 13

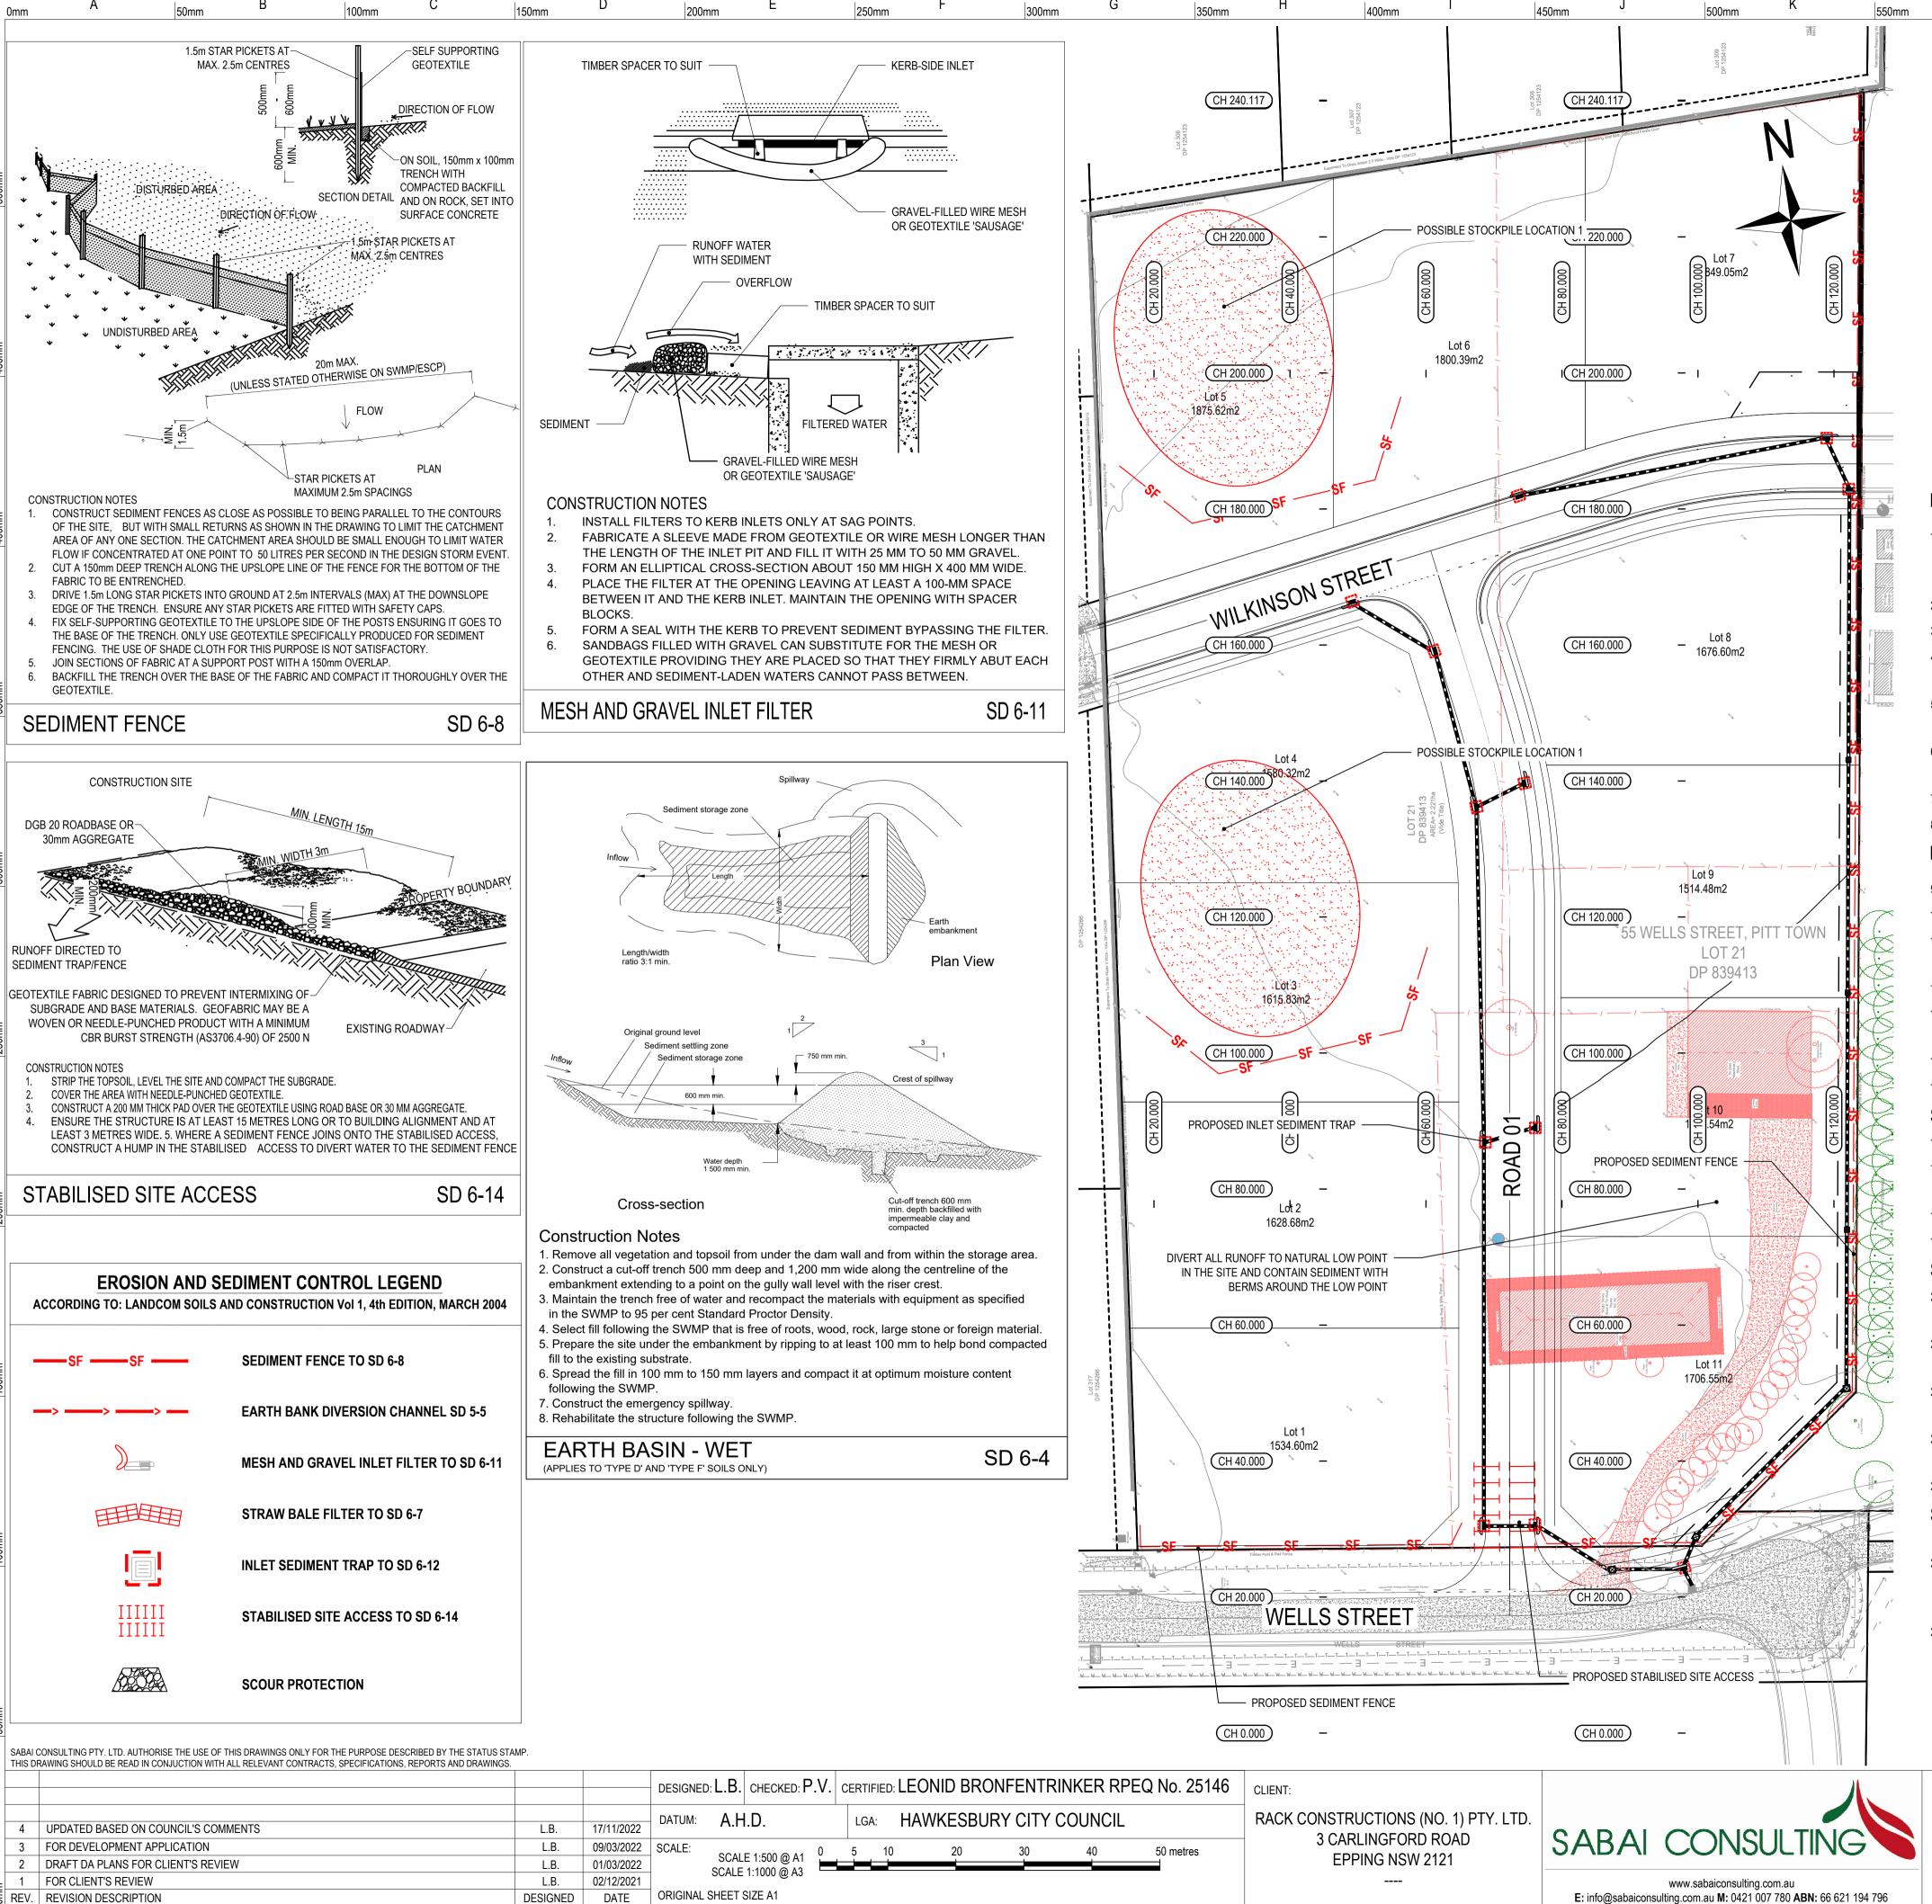

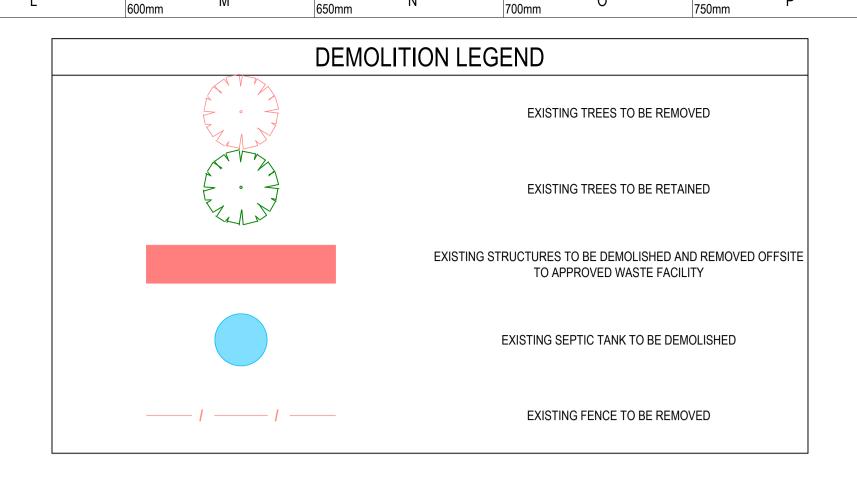

#### **EROSION AND SEDIMENT CONTROL NOTES**

- ALL EROSION AND SEDIMENT CONTROL MEASURES, INCLUDING REVEGETATION AND STORAGE OF SOIL AND TOPSOIL, SHALL BE IMPLEMENTED TO THE REQUIREMENTS OF THE "ENVIRONMENT PROTECTION AUTHORITY". AND "DEPT OF LAND AND WATER CONSERVATION". MEASURES OUTLINED IN THE SEDIMENT & EROSION CONTROL PLAN MUST BE IMPLEMENTED PRIOR TO AND MAINTAINED DURING AND AFTER THE CONSTRUCTION WORKS.
- 2. TOPSOIL FROM ALL AREAS TO BE DISTURBED SHALL BE STOCKPILED AND LATER RESPREAD TO AID REVEGETATION IN THOSE AREAS.
- 3. ALL DRAINAGE WORKS SHALL BE CONSTRUCTED AND STABILIZED AS EARLY AS POSSIBLE DURING DEVELOPMENT.
- 4. ALL TAIL-OUT DRAINS SHALL BE GRASSED AND TRAPEZOIDAL IN SECTION. STRAW BALES SHALL BE PLACED AS A SEDIMENT CONTROL DEVICE WHERE REQUIRED.
- 5. VEHICULAR TRAFFIC SHALL BE CONTROLLED DURING DEVELOPMENT CONFINING ACCESS WHERE POSSIBLE TO PROPOSED OR EXISTING ROAD ALIGNMENTS. AREAS TO BE LEFT UNDISTURBED SHALL BE MARKED OFF.
- 6. DISTURBANCE OF VEGETATION SHALL BE LIMITED TO FILL AREAS, ROADWAYS AND DRAINAGE LINES. NO LOT GRADING SHALL BE CARRIED OUT IN UNDISTURBED AREAS WITHOUT CONSULTATION WITH COUNCIL'S ENGINEER.
- 7. ALL DISTURBED AREAS SHALL BE REVEGETATED WITHIN 14 WORKING DAYS FROM THE CONCLUSION OF LAND SHAPING.
- 8. MINIMISE DUST BY WATERING WHEN REQUIRED.

#### **DEMOLITION NOTES**

- 9. CONTRACTOR TO ESTABLISH EXTENT OF ALL EXISTING SERVICES WITHIN THE EXTENT OF WORKS.
- 10. CONTRACTOR TO GAIN ALL NESSARY APPROVALS AND PERMITS TO DEMOLISH, CAP OR REMOVED EXISTING SERVICES AS REQUIRED.
- 11. CONTRACTOR TO ALLOW FOR THE DEMOLITION OF ALL EXISTING STRUCTURES AND FEATURES (ABOVE AND BELOW GROUND) ON THE SITE, INCLUDING BUILDINGS, FENCES, EXISTING PAVEMENT, DRAINAGE, SIGNS ETC.
- 12. ALL DEMOLITION WORKS SHALL COMPLY WITH THE PROVISIONS OF AS2601:2001 THE DEMOLITION OF STRUCTURES.
- 13. REMOVAL OF EXISTING ELECTRICAL INFRASTRUCTURE TO BE COMPLETED IN ACCORDANCE WITH ELECTRICAL CONSULTANTS SPECIFICATIONS AND DRAWINGS
- 14. EXISTING SERVICES TO BE LOCATED FROM ONSITE SERVICES LOCATION.
- 15. TREE REMOVAL SHALL BE IN ACCORDANCE WITH HAWKESBURY CITY COUNCIL'S REQUIREMENTS AND SPECIFICATIONS.

#### STOCKPILE NOTES

- 16. SPOIL AND TOPSOIL STOCKPILES SHALL BE LOCATED AWAY FROM DRAINAGE LINES AND AREAS WHERE WATER MAY CONCENTRATE.
- 17. IF STOCKPILES ARE TO BE IN PLACE FOR LONGER THAN 14 DAYS THEN THEY SHALL BE STABILIZED BY COVERING WITH A MULCH OR WITH TEMPORARY VEGETATION.
- 18. FOLLOWING CONSTRUCTION, TOPSOIL SHALL BE RESPREAD TO A MINIMUM DEPTH OF 100MM ON THE BARE SOIL SURFACES AND REVEGETATE.
- 19. ALL STOCKPILES TO BE (MAX) 2M HIGH AND PROTECTED WITH SILT FENCE.

#### SPECIAL NOTES

- 20. LOCATION AND EXTENT OF SOIL AND WATER MANAGEMENT DEVICES IS DIAGRAMMATIC ONLY AND THE ACTUAL REQUIREMENTS SHALL BE CONFIRMED ON SITE.
- 21. THIS PLAN IS TO BE READ IN CONJUNCTION WITH THE GUIDELINES SET OUT IN "MANAGING URBAN STORMWATER SOILS AND CONSTRUCTION " -4TH EDITION AND THE ACCOMPANYING ROAD AND DRAINAGE PLANS.
- 22. CONFORMITY WITH THIS PLAN SHALL IN NO WAY REDUCE THE RESPONSIBILITY OF THE CONTRACTOR TO PROTECT AGAINST WATER DAMAGE DURING THE COURSE OF THE CONTRACT.
- 23. MANAGEMENT DEVICES SHALL BE MAINTAINED ON A REGULAR BASIS. WHERE CLEANING IS REQUIRED, THE SEDIMENT SHALL BE REMOVED TO A POINT NOMINATED BY THE ENGINEER.
- 24. MANAGEMENT DEVICES TO REMAIN UNTIL THE END OF THE MAINTENANCE PERIOD

#### SEDIMENT CONTROL DEVICES

- 25. ALL STRAW BALES SHALL BE BOUND WITH WIRE. STRAW BALES SHALL BE PLACED END TO END IN A SINGLE ROW AND EMBEDDED INTO THE SOIL TO A DEPTH OF 100MM. EACH BALE SHALL BE SECURELY ANCHORED WITH TWO STEEL STAKES DRIVEN 450MM INTO THE GROUND AND LOCATED ON THE BALE CENTRE LINE.
- 26. SILT FENCES SHALL BE CONSTRUCTED BY STRETCHING A FILTER FABRIC (PROPEX OR SIMILAR) BETWEEN POSTS AT 2M (3M MAX) CENTRES. FABRIC SHALL BE BURIED 150MM ALONG ITS LOWER EDGE.

PRELIMINARY ISSUE - NOT FOR CONSTRUCTION

PROJECT No.: 2168




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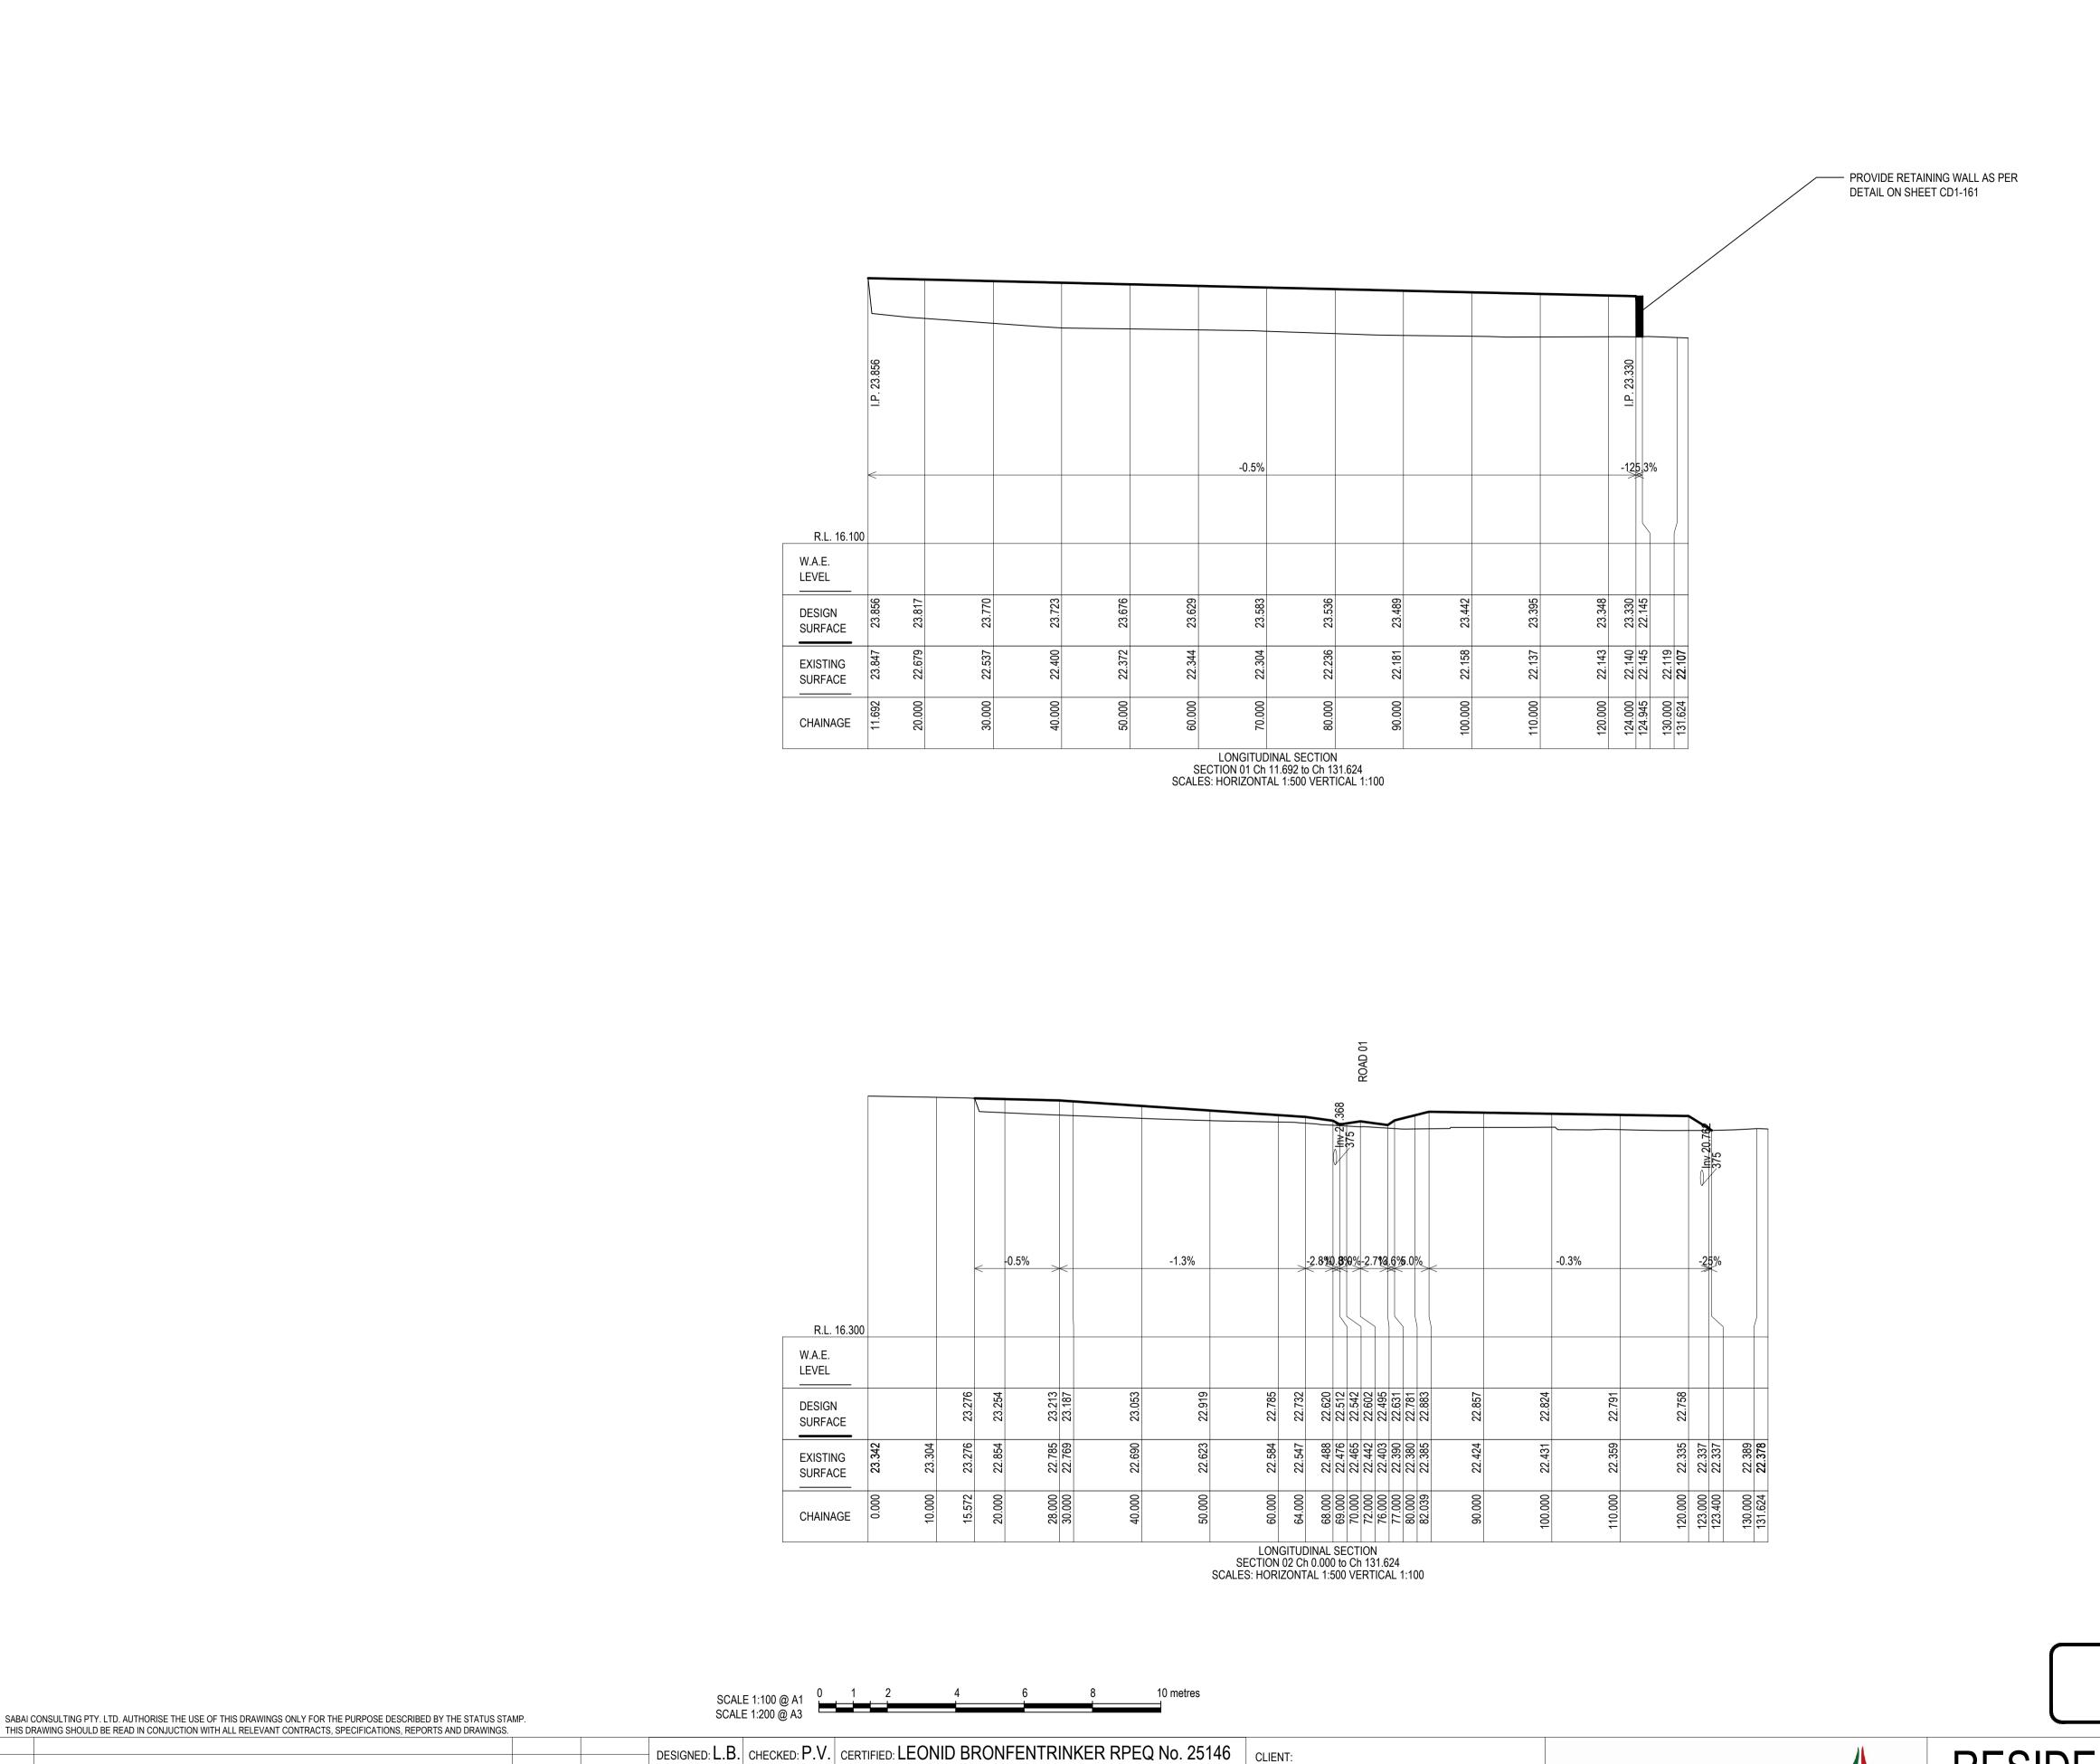
55 WELLS STREET, PITT TOWN
DEMOLITION TREE REMOVAL AND EROSION AND

DEMOLITION, TREE REMOVAL AND EROSION AND SEDIMENT CONTROL PLAN

DWG No.: CD1-110

SHEET 3 OF 13



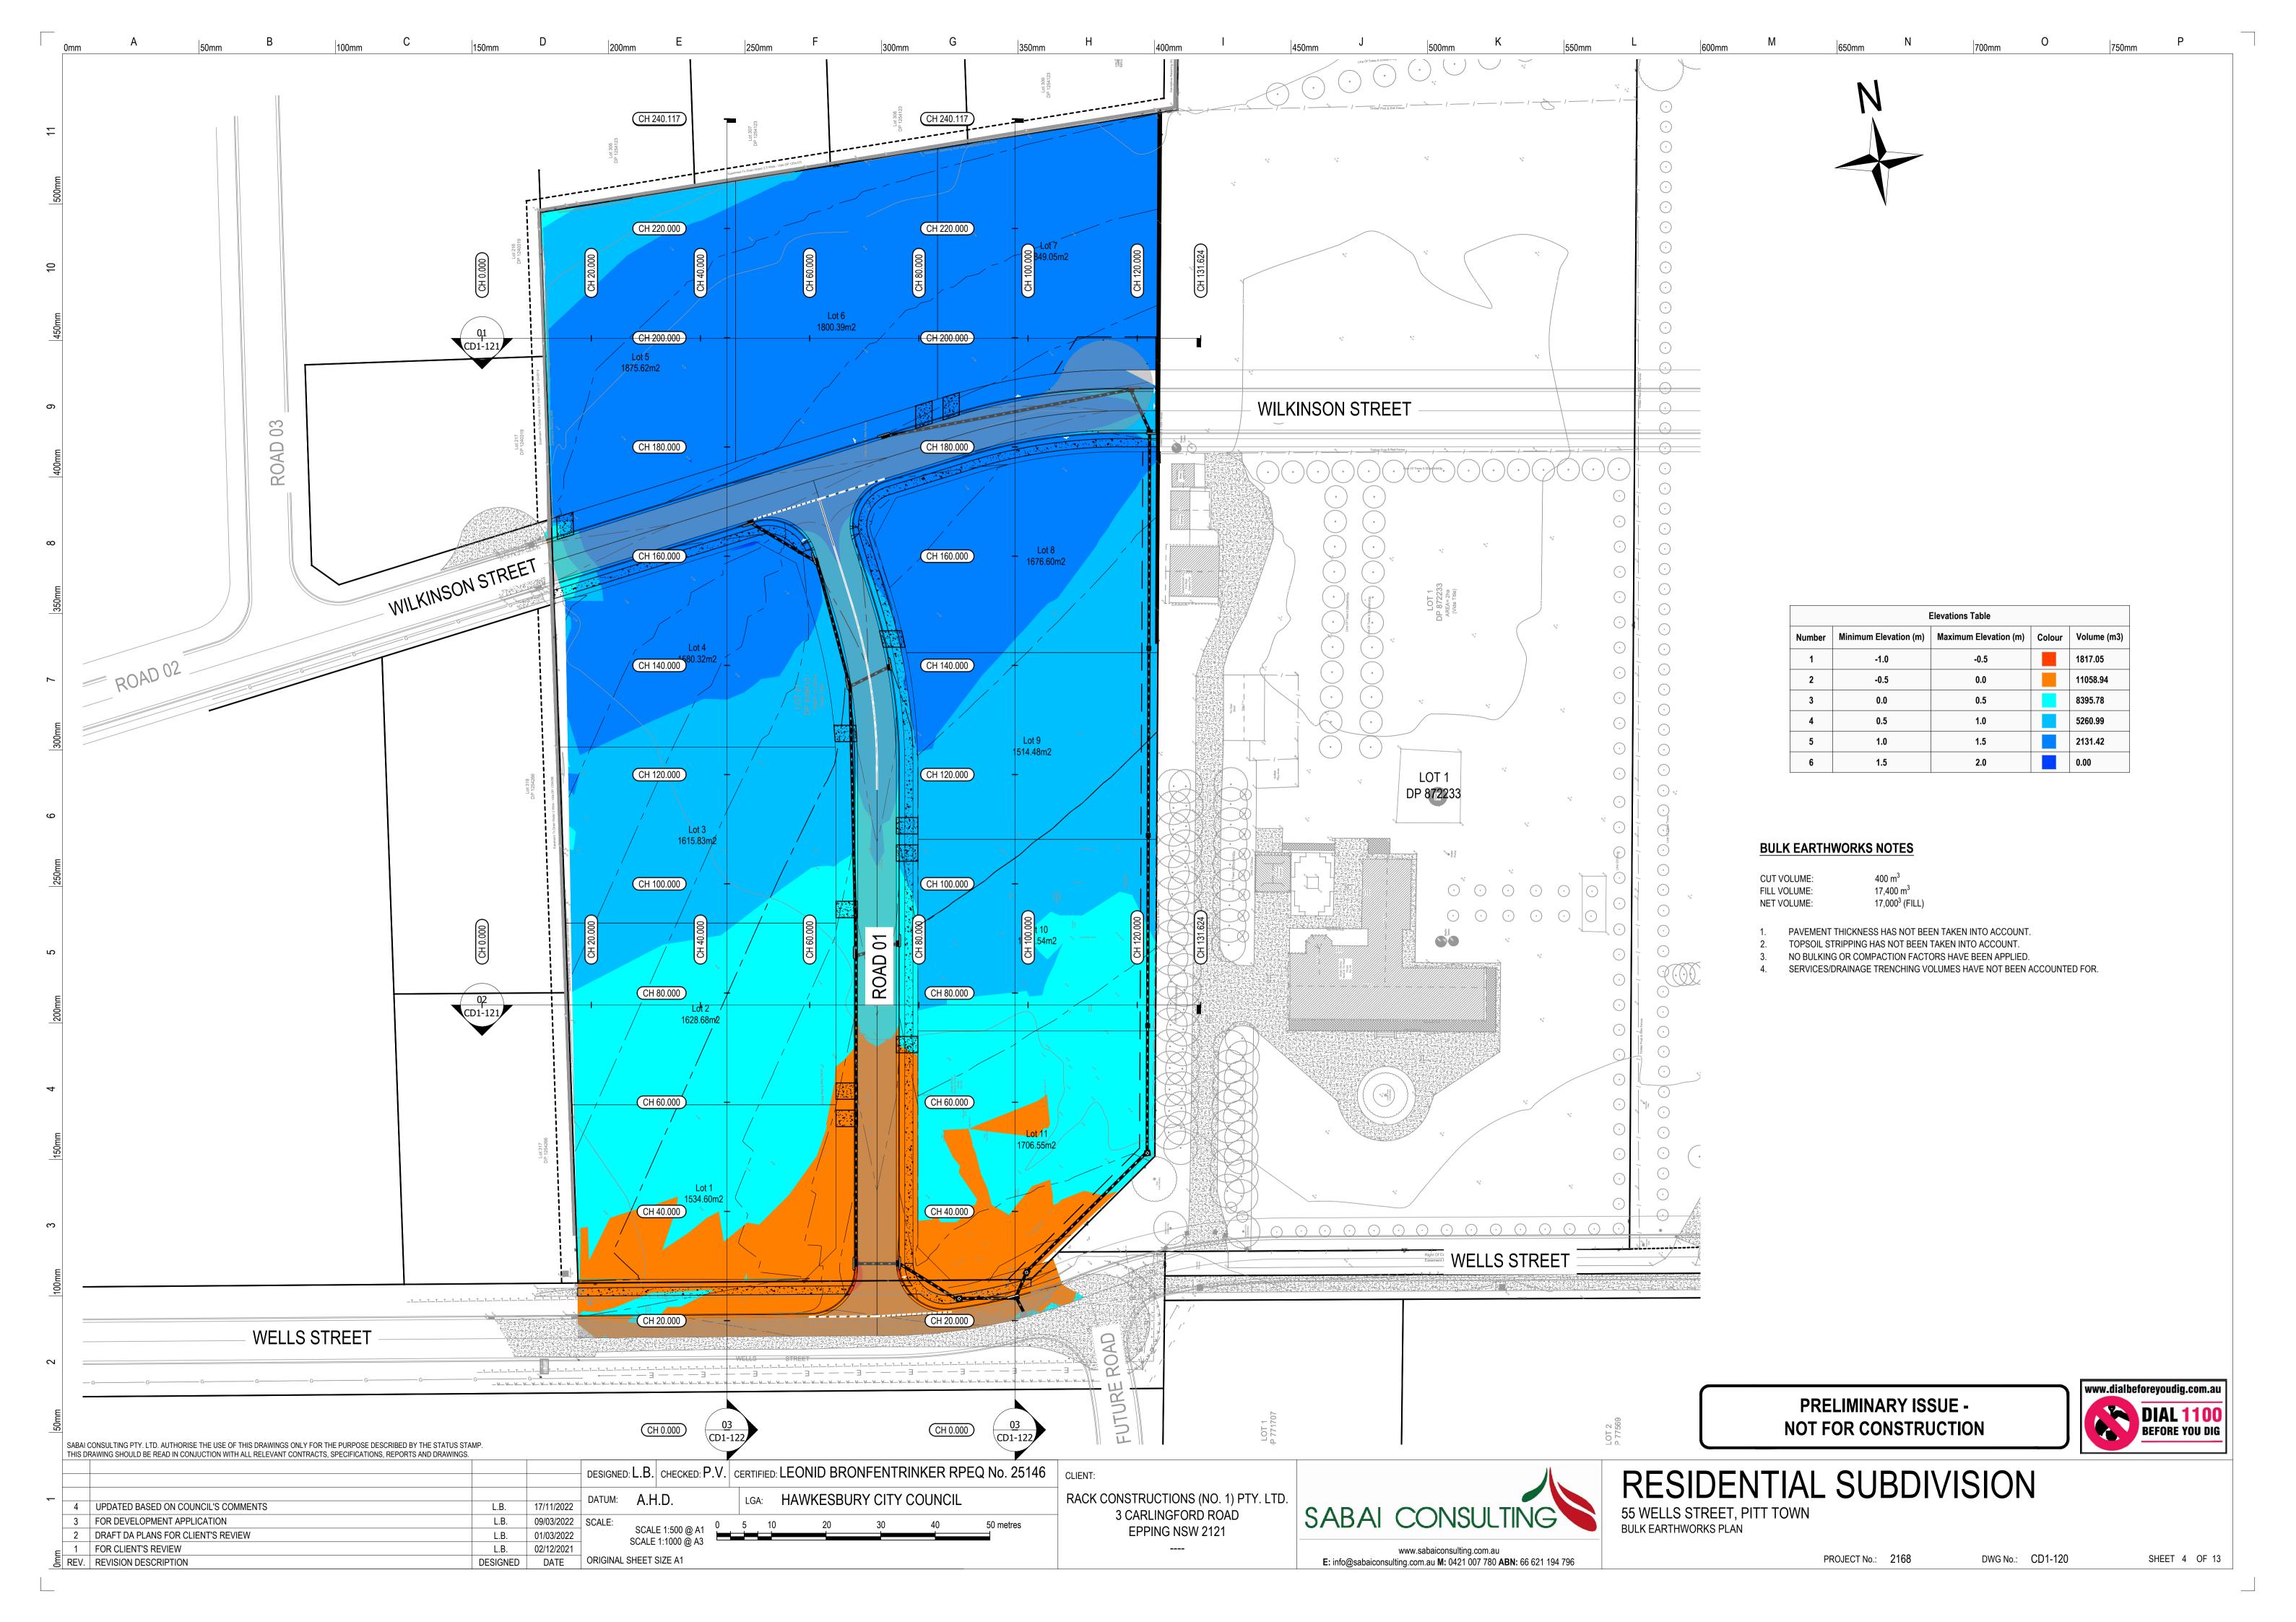

LGA: HAWKESBURY CITY COUNCIL

DATUM: A.H.D.

SCALE 1:500 @ A1

SCALE 1:1000 @ A3

L.B. 17/11/2022

L.B. 02/12/2021

L.B.

L.B. 09/03/2022 SCALE:

01/03/2022

DESIGNED DATE ORIGINAL SHEET SIZE A1

4 UPDATED BASED ON COUNCIL'S COMMENTS

DRAFT DA PLANS FOR CLIENT'S REVIEW

FOR DEVELOPMENT APPLICATION

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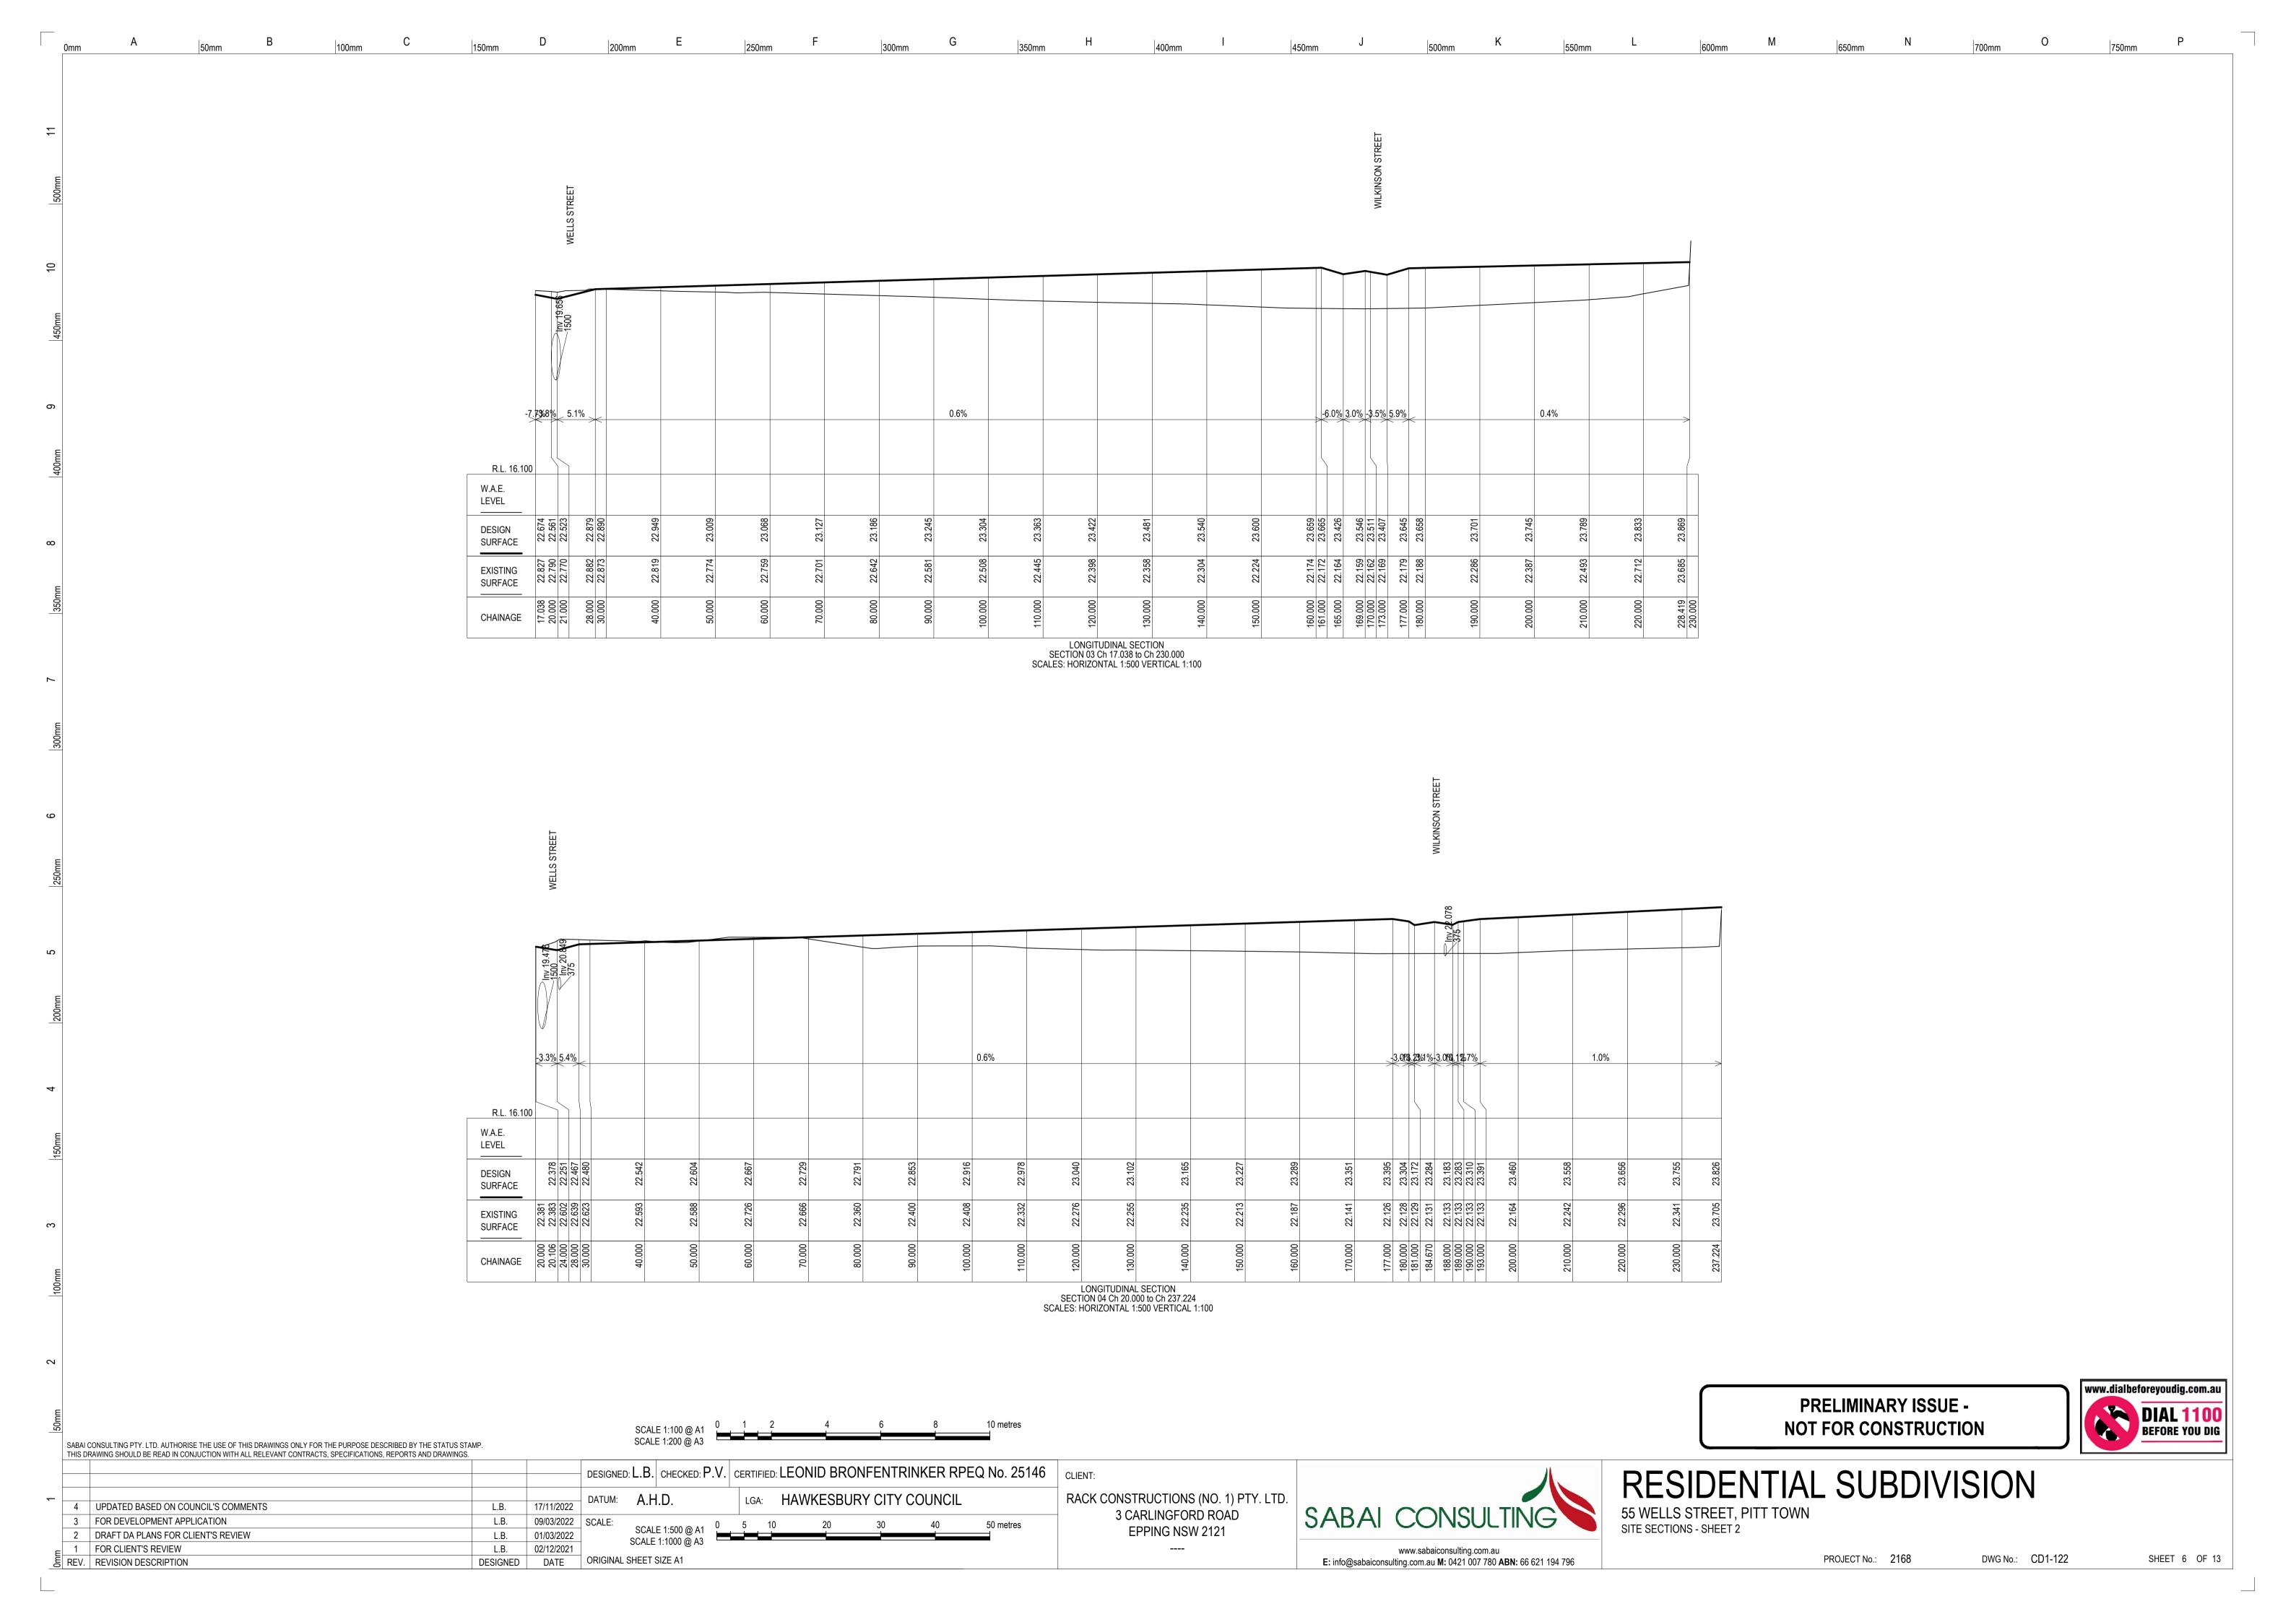
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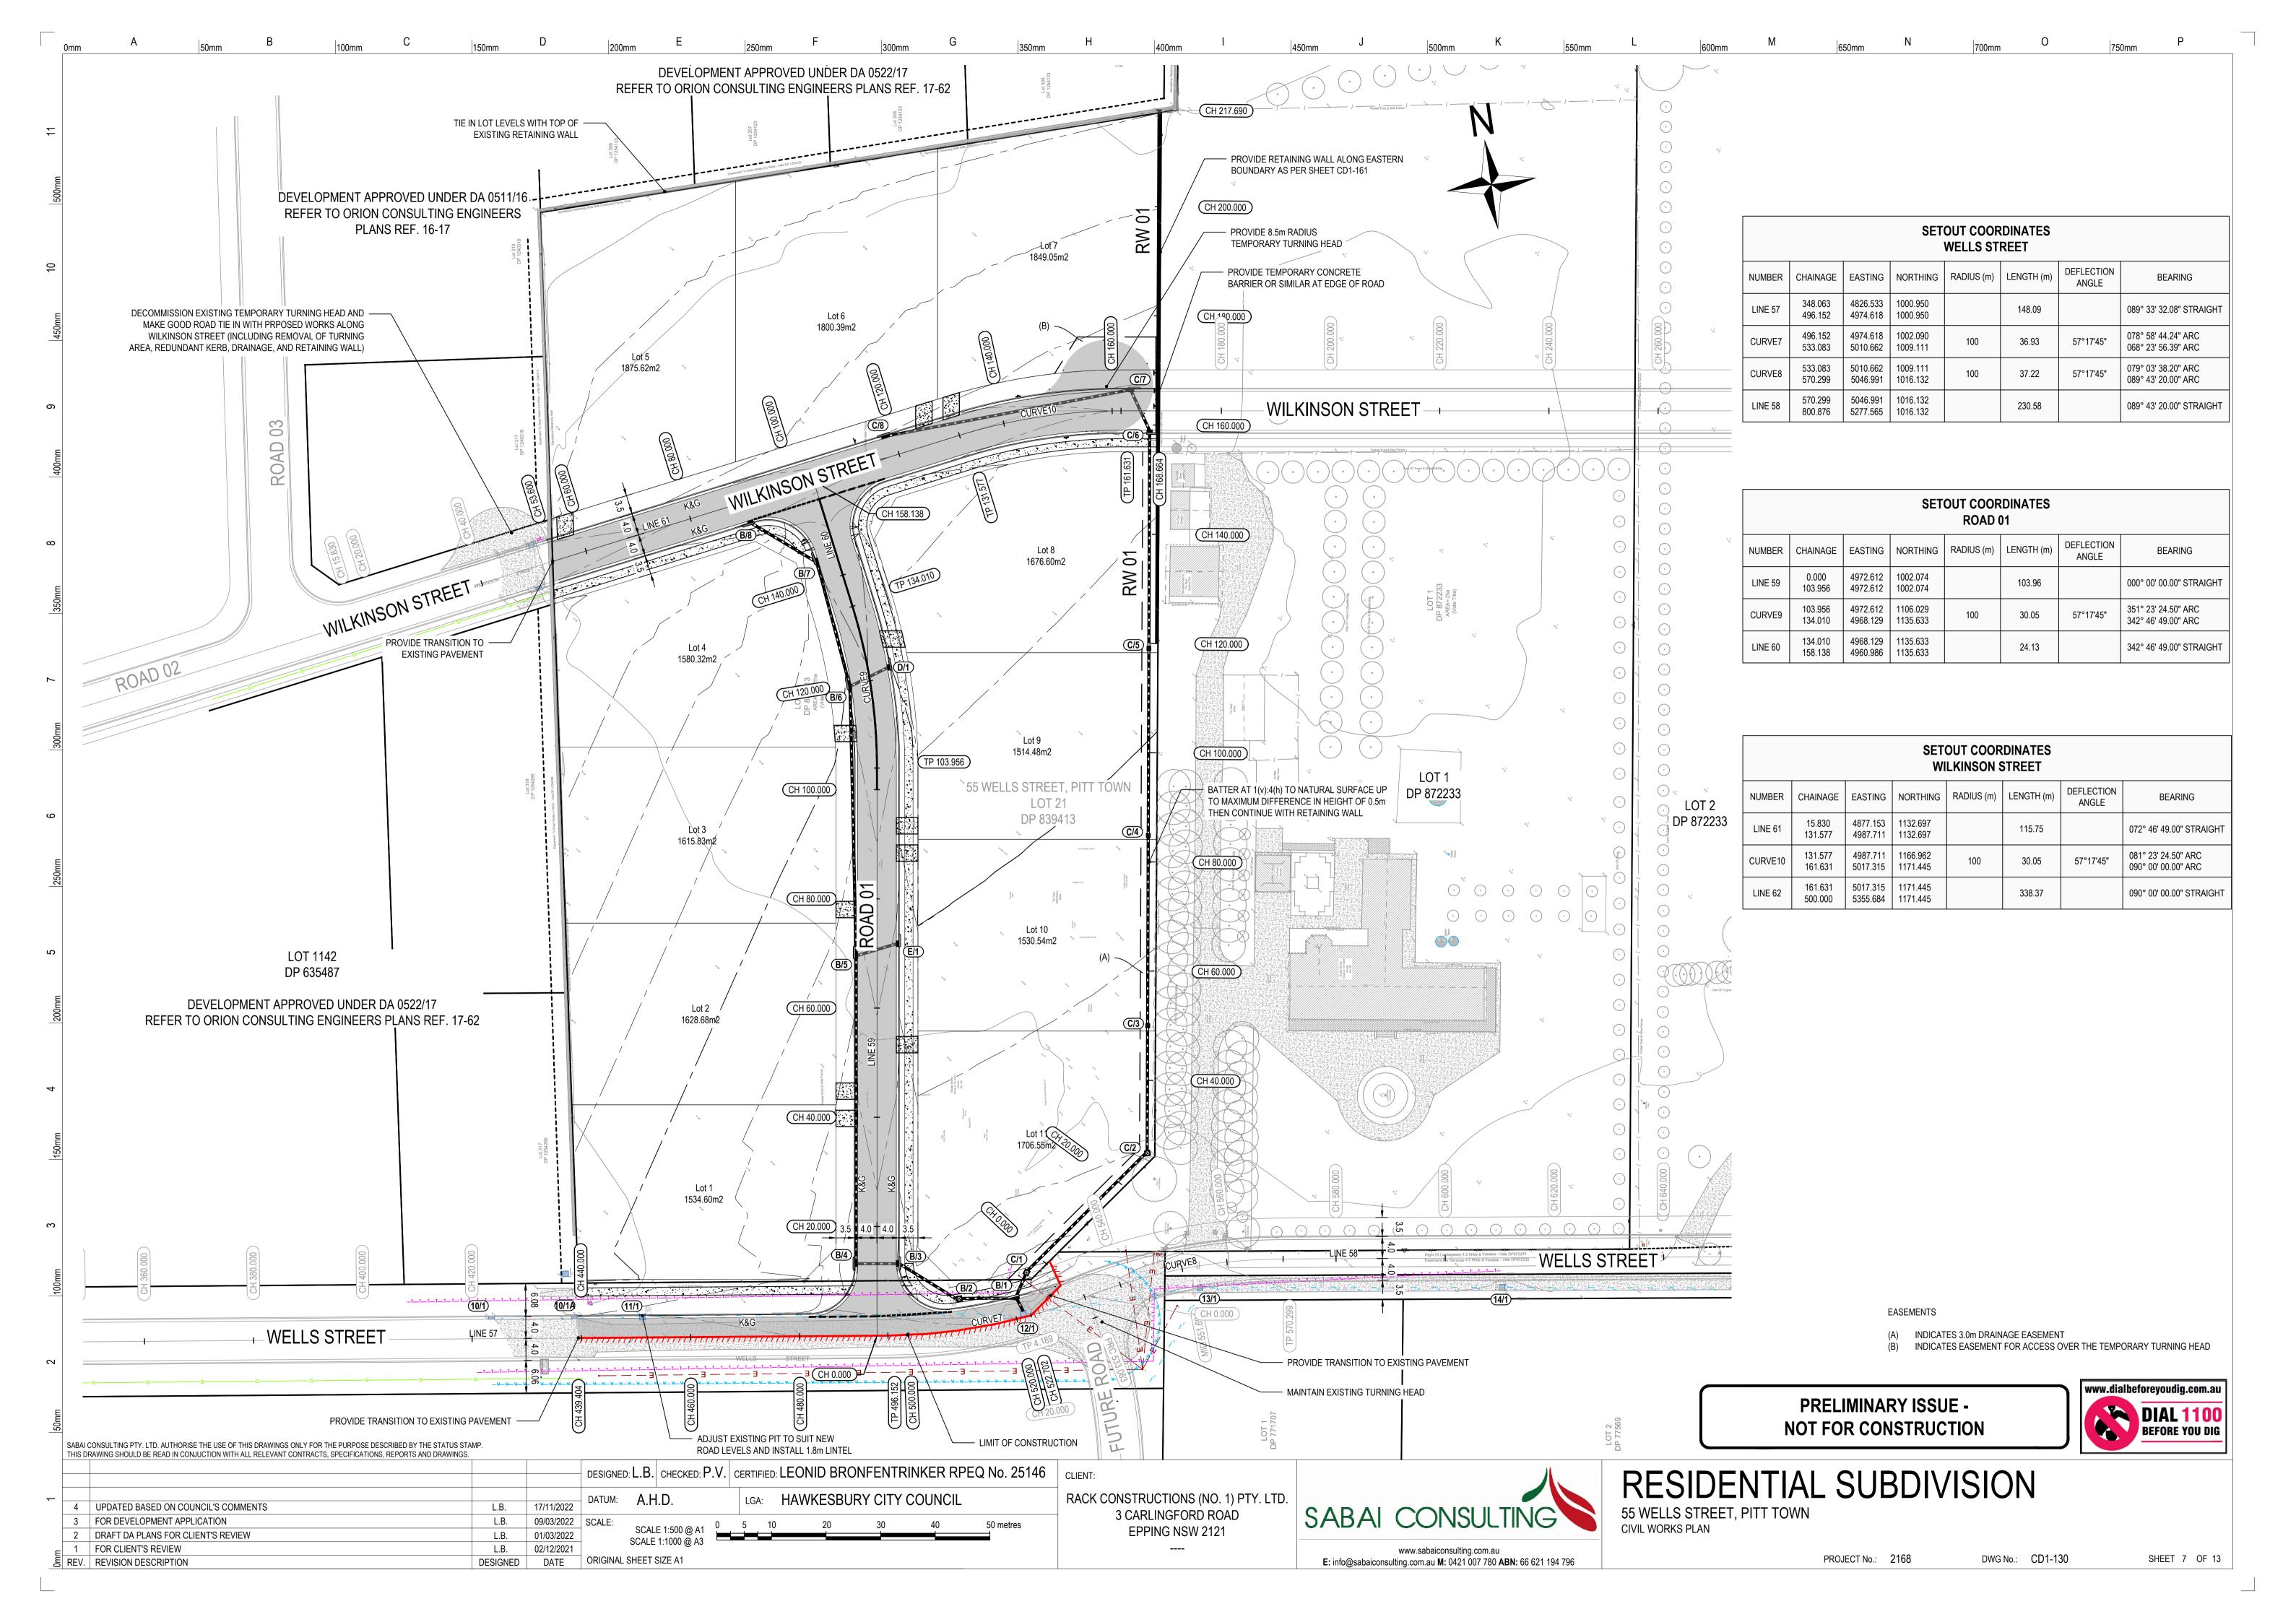
55 WELLS STREET, PITT TOWN SITE SECTIONS - SHEET 1

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PROJECT No.: 2168


DWG No.: CD1-121 SHEET 5 OF 13





PROPOSED ROAD UIPGRADE EXISTING ROAD AND FUTURE UPGRADE EXISTING FORMATION EXISTING ROAD RESERVE INDICATIVE WELLS STREET 20.118m WIDE INDICATIVE FUTURE HALF-ROAD TRUNK DRAINAGE LINE CONSTRUCTION BY OTHERS VERGE 6.06m WIDE CARRIAGEWAY VERGE 8.0m WIDE 6.06m WIDE -4.18 -4.00 -3.55 OFFSET

TYPICAL CROSS SECTION - WELLS STREET

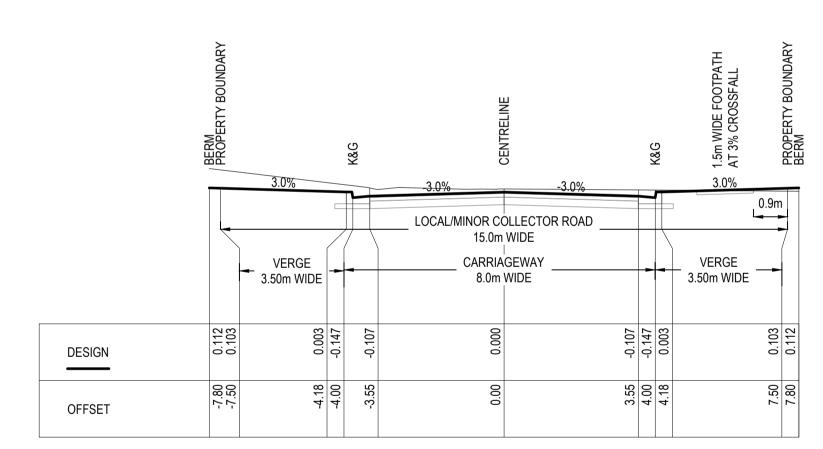

TYPICAL CROSS SECTION - WILKINSON STREET AND ROAD 01
Scale: 1:100

NOTE:

PAVEMENT COMPOSITION AS PER FUTURE GEOTECHNICAL DESIGN TO BE UNDERTAKEN DURING THE CONSTRUCTION CERTIFICATE STAGE.

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-					DESIGNED: L.B.	CHECKED: P.V.	CERTIFIE	: <b>LEONID</b>	BRONE	ENTRI	NKER RP	EQ No. 25146
_					DATUM: A.F	H.D.	LGA:	HAWKE	SBURY	CITY C	OUNCIL	
	3	FOR DEVELOPMENT APPLICATION	L.B.	09/03/2022	SCALE:	54400044 0	1 2	2 4		6	8	10 metres
	2	DRAFT DA PLANS FOR CLIENT'S REVIEW	L.B.	01/03/2022	SCAL	_E 1:100 @ A1 _E 1:200 @ A3						
ج	1	FOR CLIENT'S REVIEW	L.B.	02/12/2021	SCAL	.E 1.200 @ A3						
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RACK CONSTRUCTIONS (NO. 1) PTY. LTD.

3 CARLINGFORD ROAD

EPPING NSW 2121

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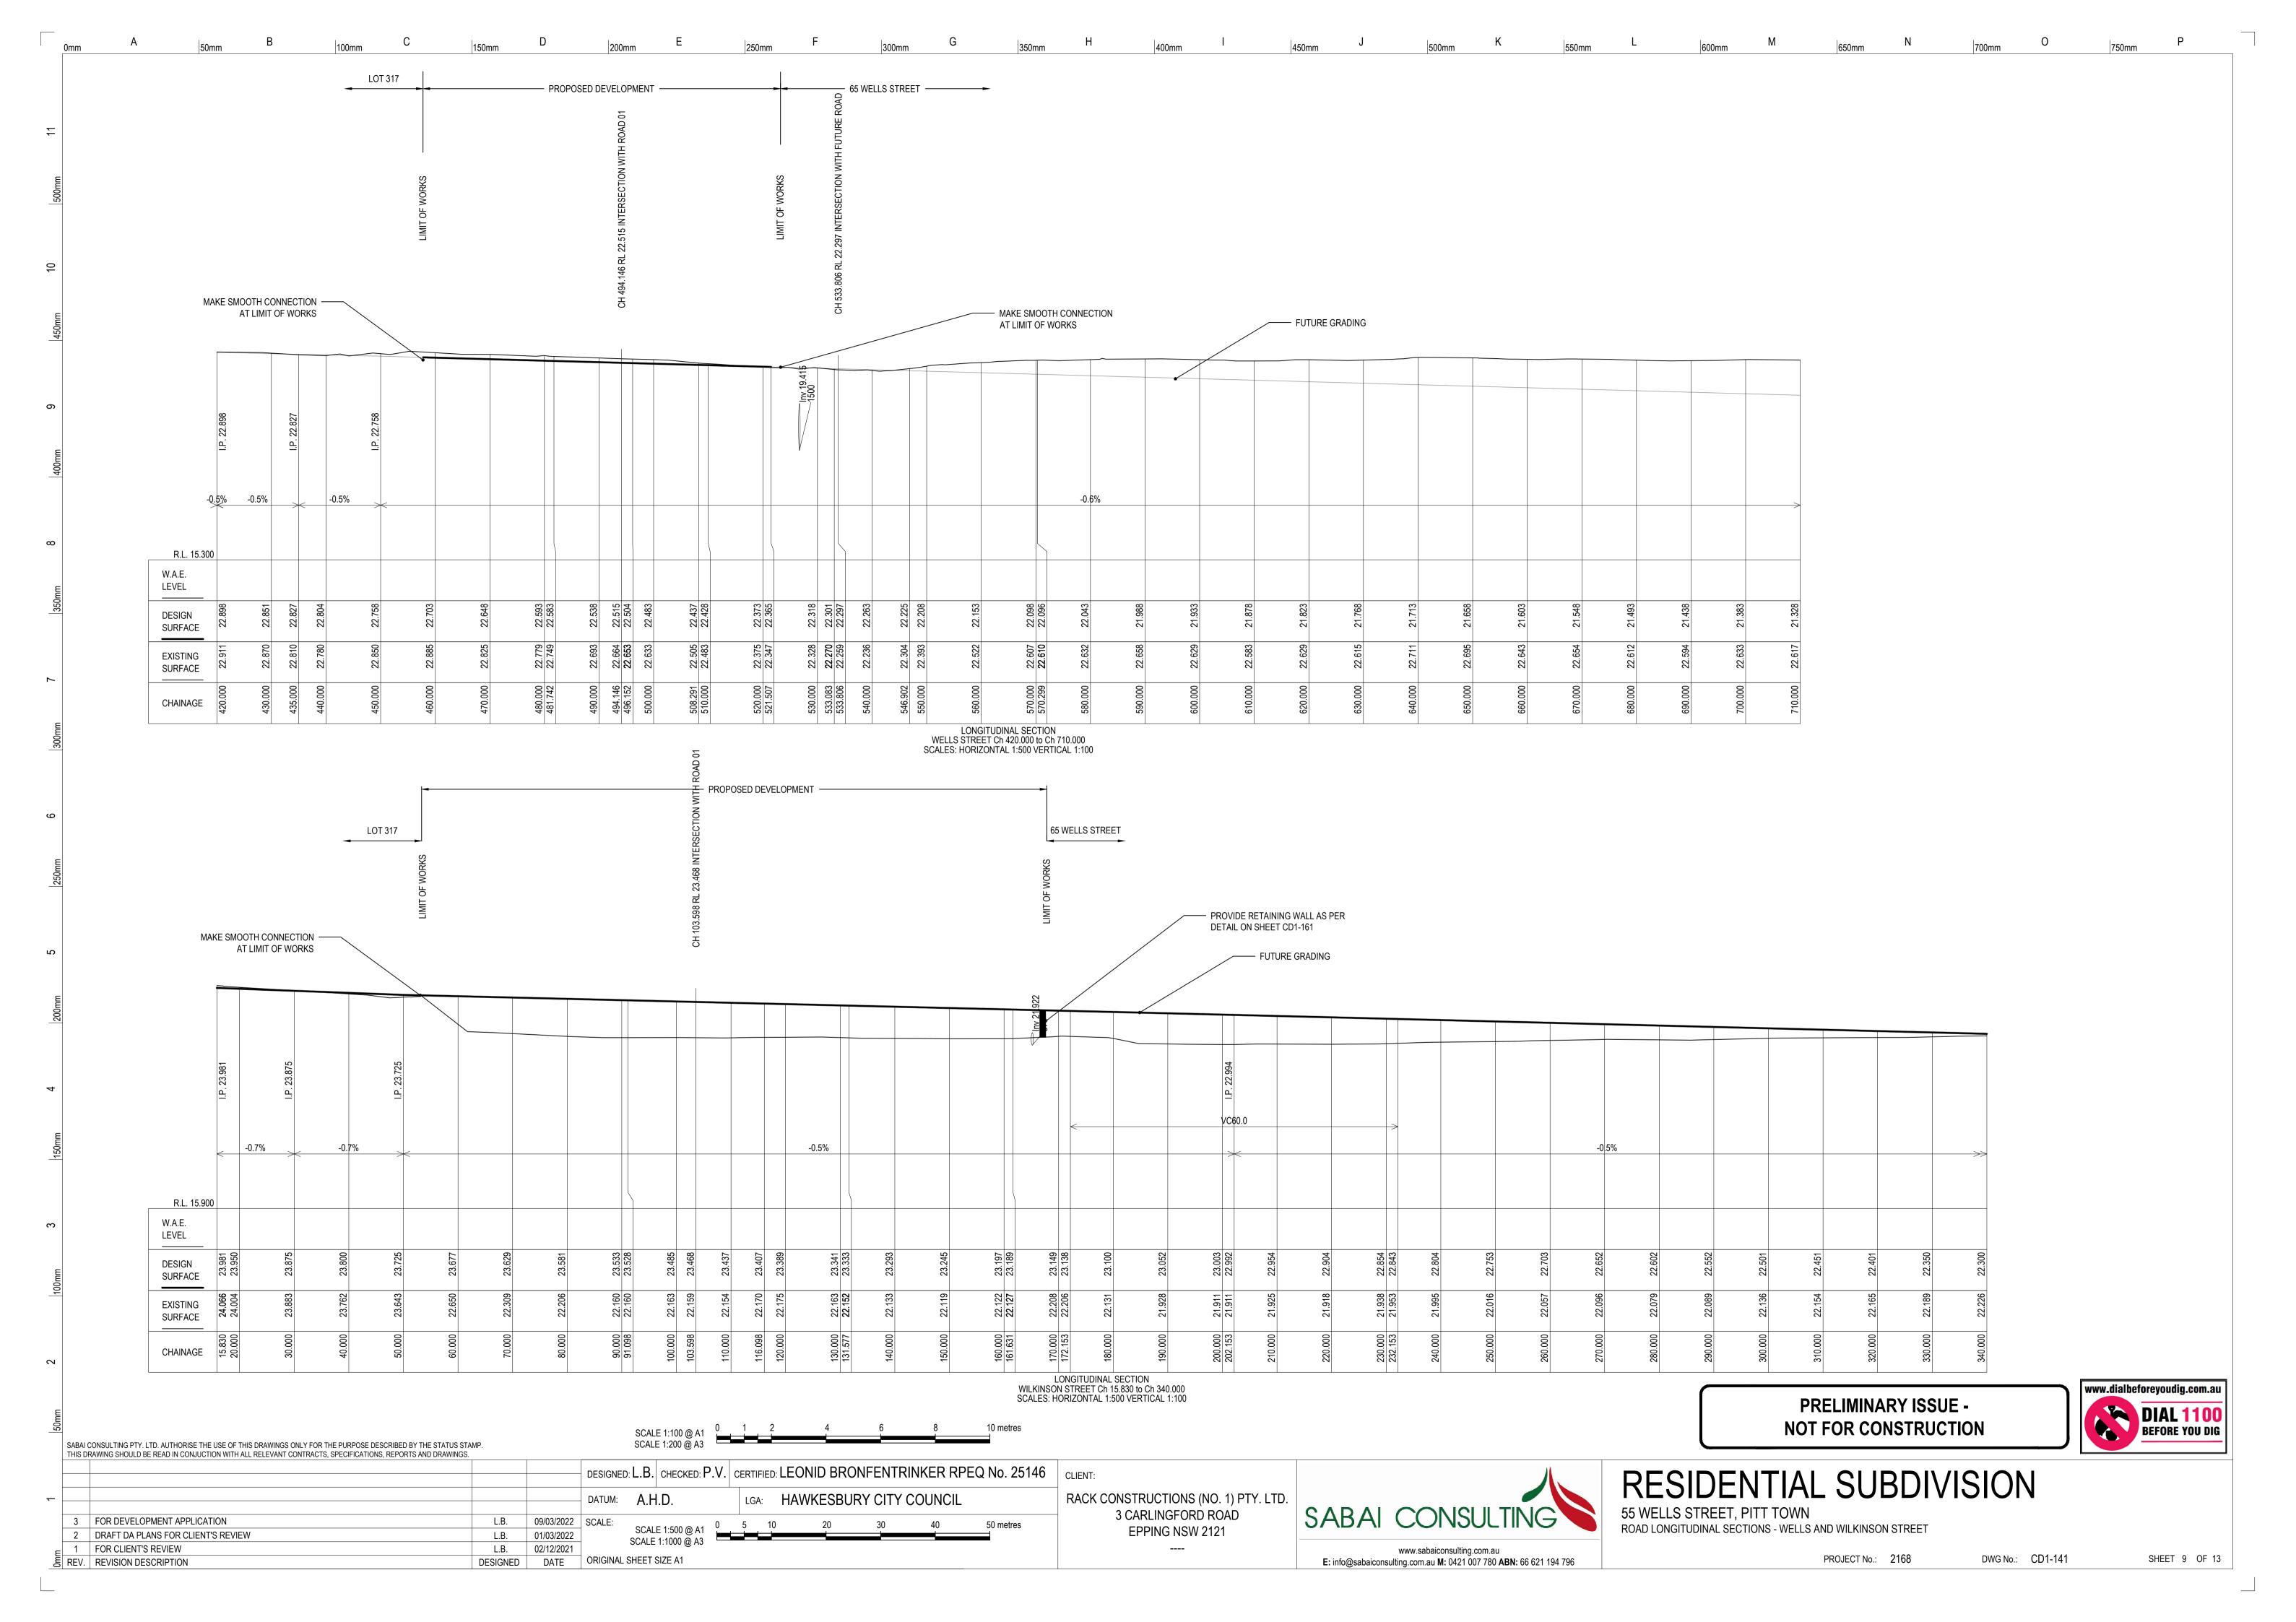



RESIDENTIAL	SUBDIVISION
55 WELLS STREET, PITT TOWN	

ROAD TYPICAL DETAILS

PROJECT No.: 2168 DWG No.: CD1-140

SHEET 8 OF 13



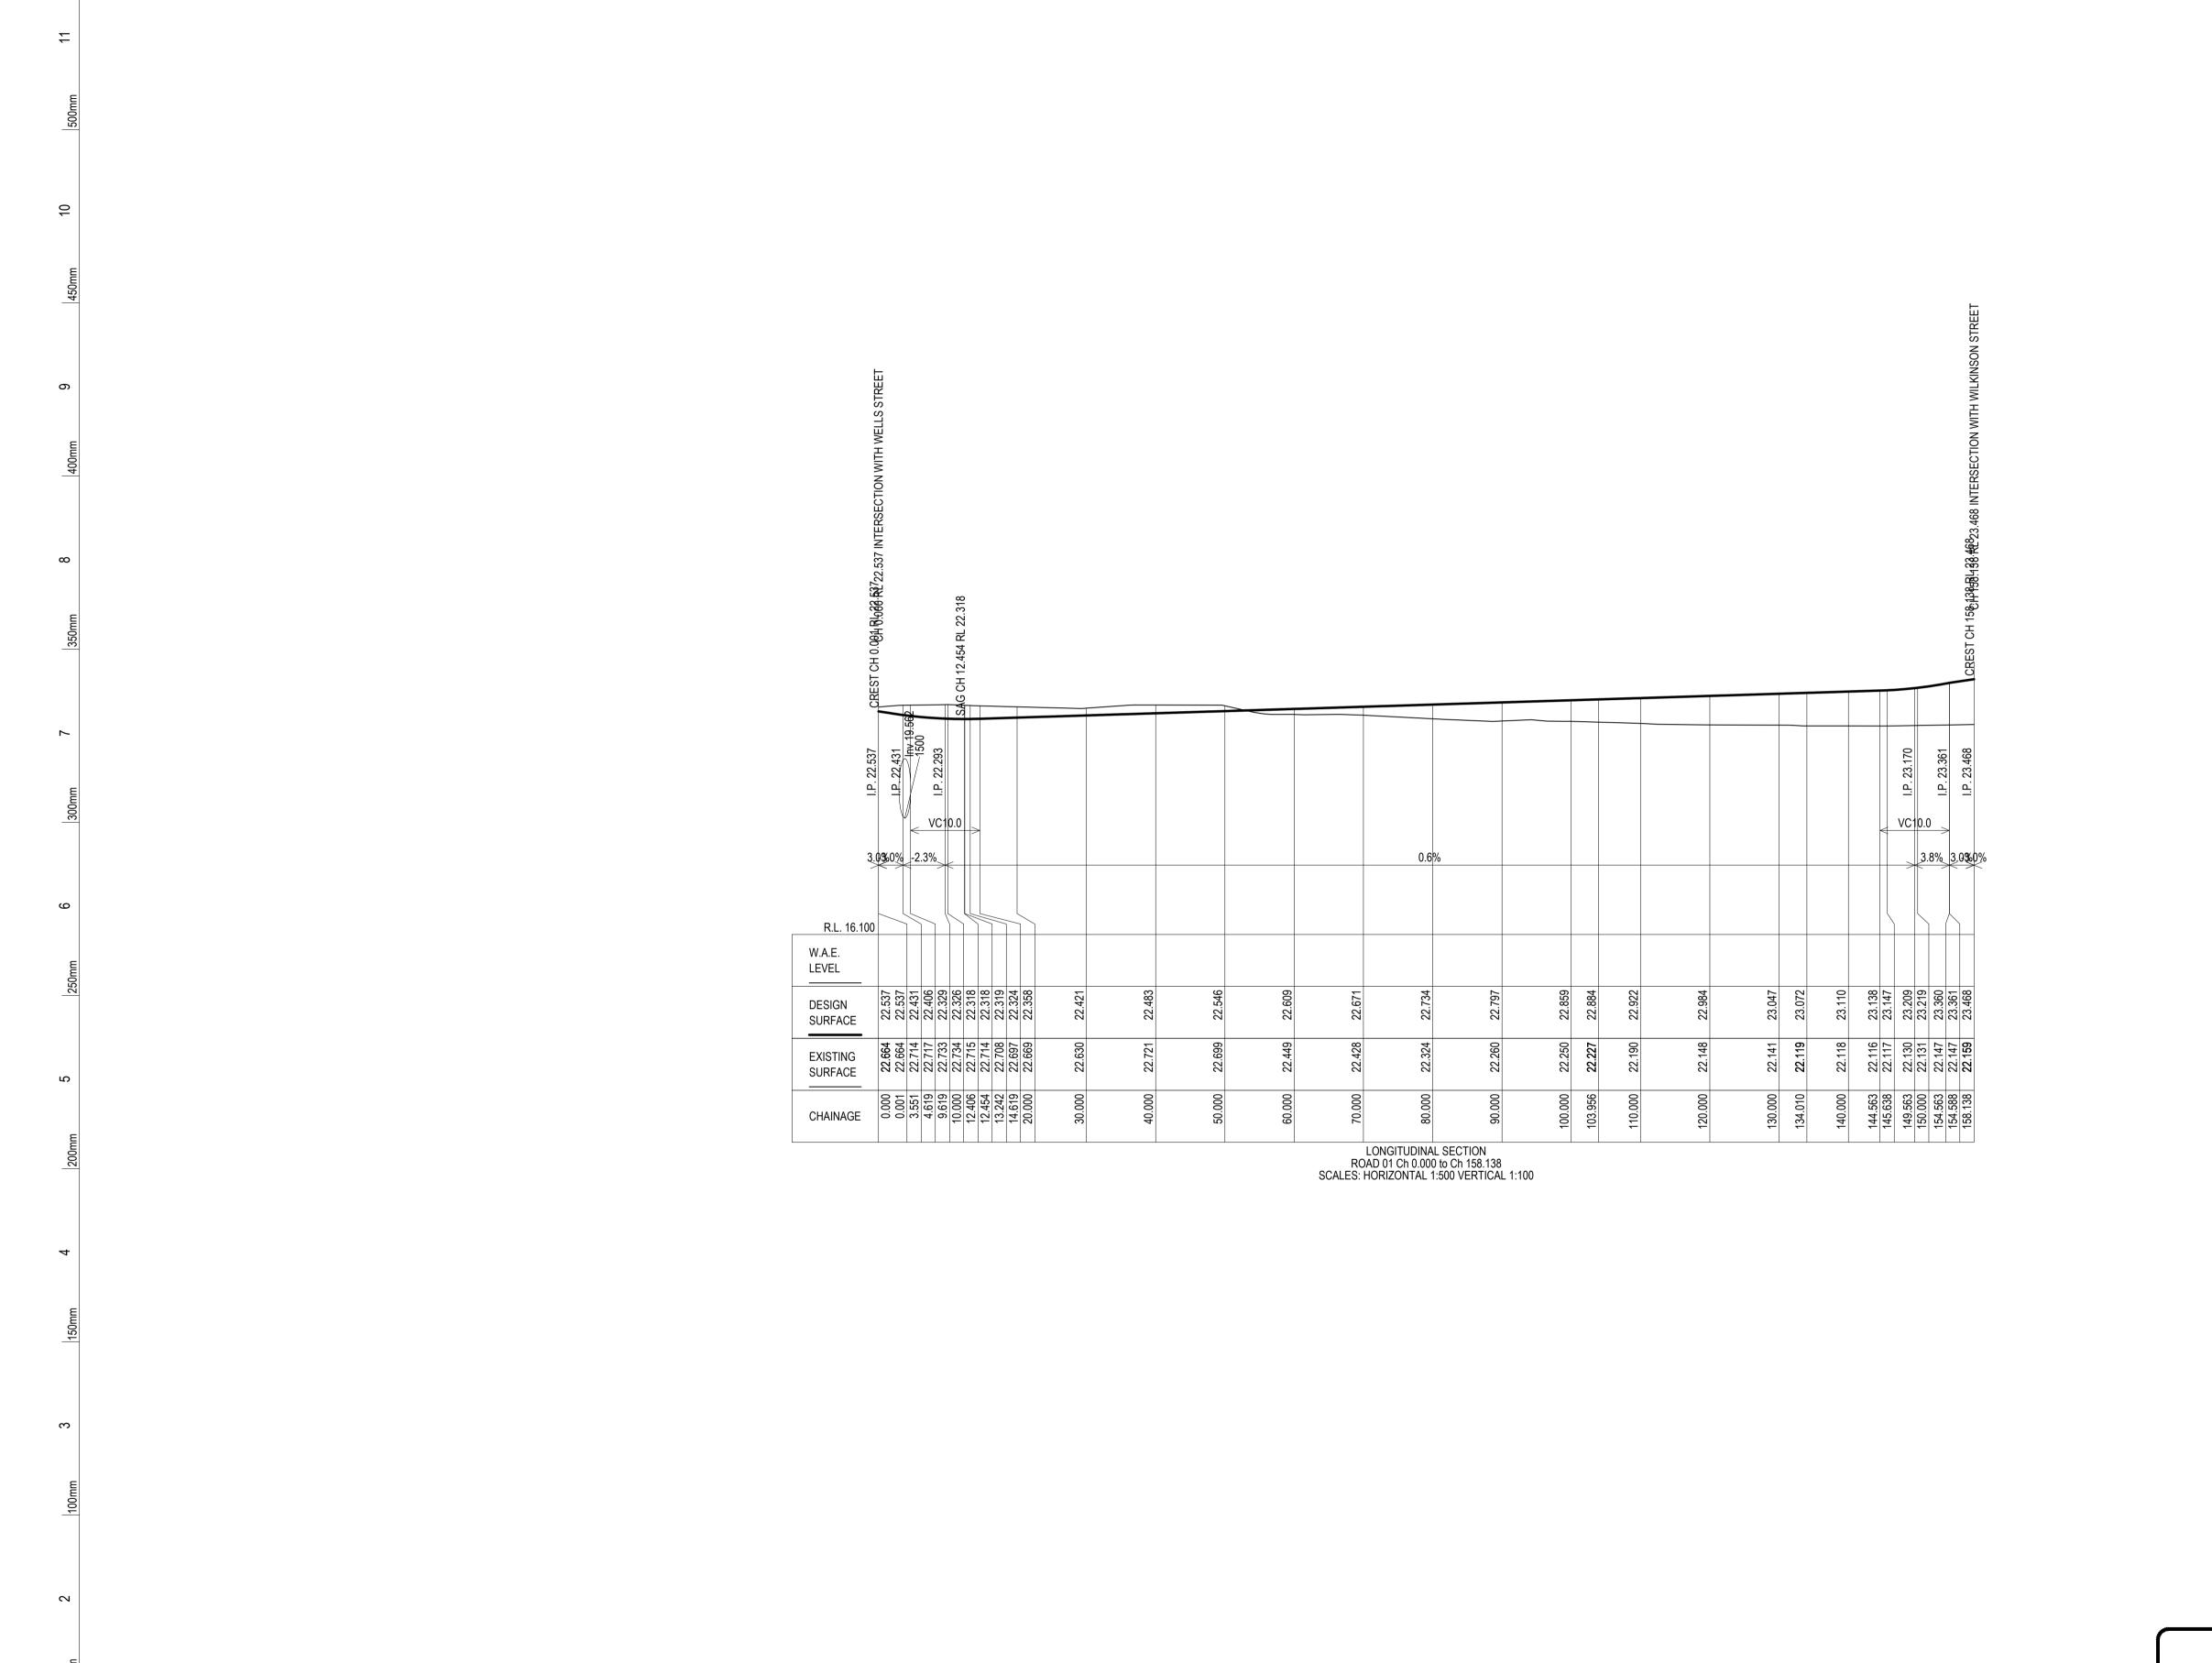

SCALE 1:100 @ A1 SCALE 1:200 @ A3

DATUM: A.H.D.

L.B. 09/03/2022 SCALE:

L.B. 02/12/2021

01/03/2022

DESIGNED DATE ORIGINAL SHEET SIZE A1

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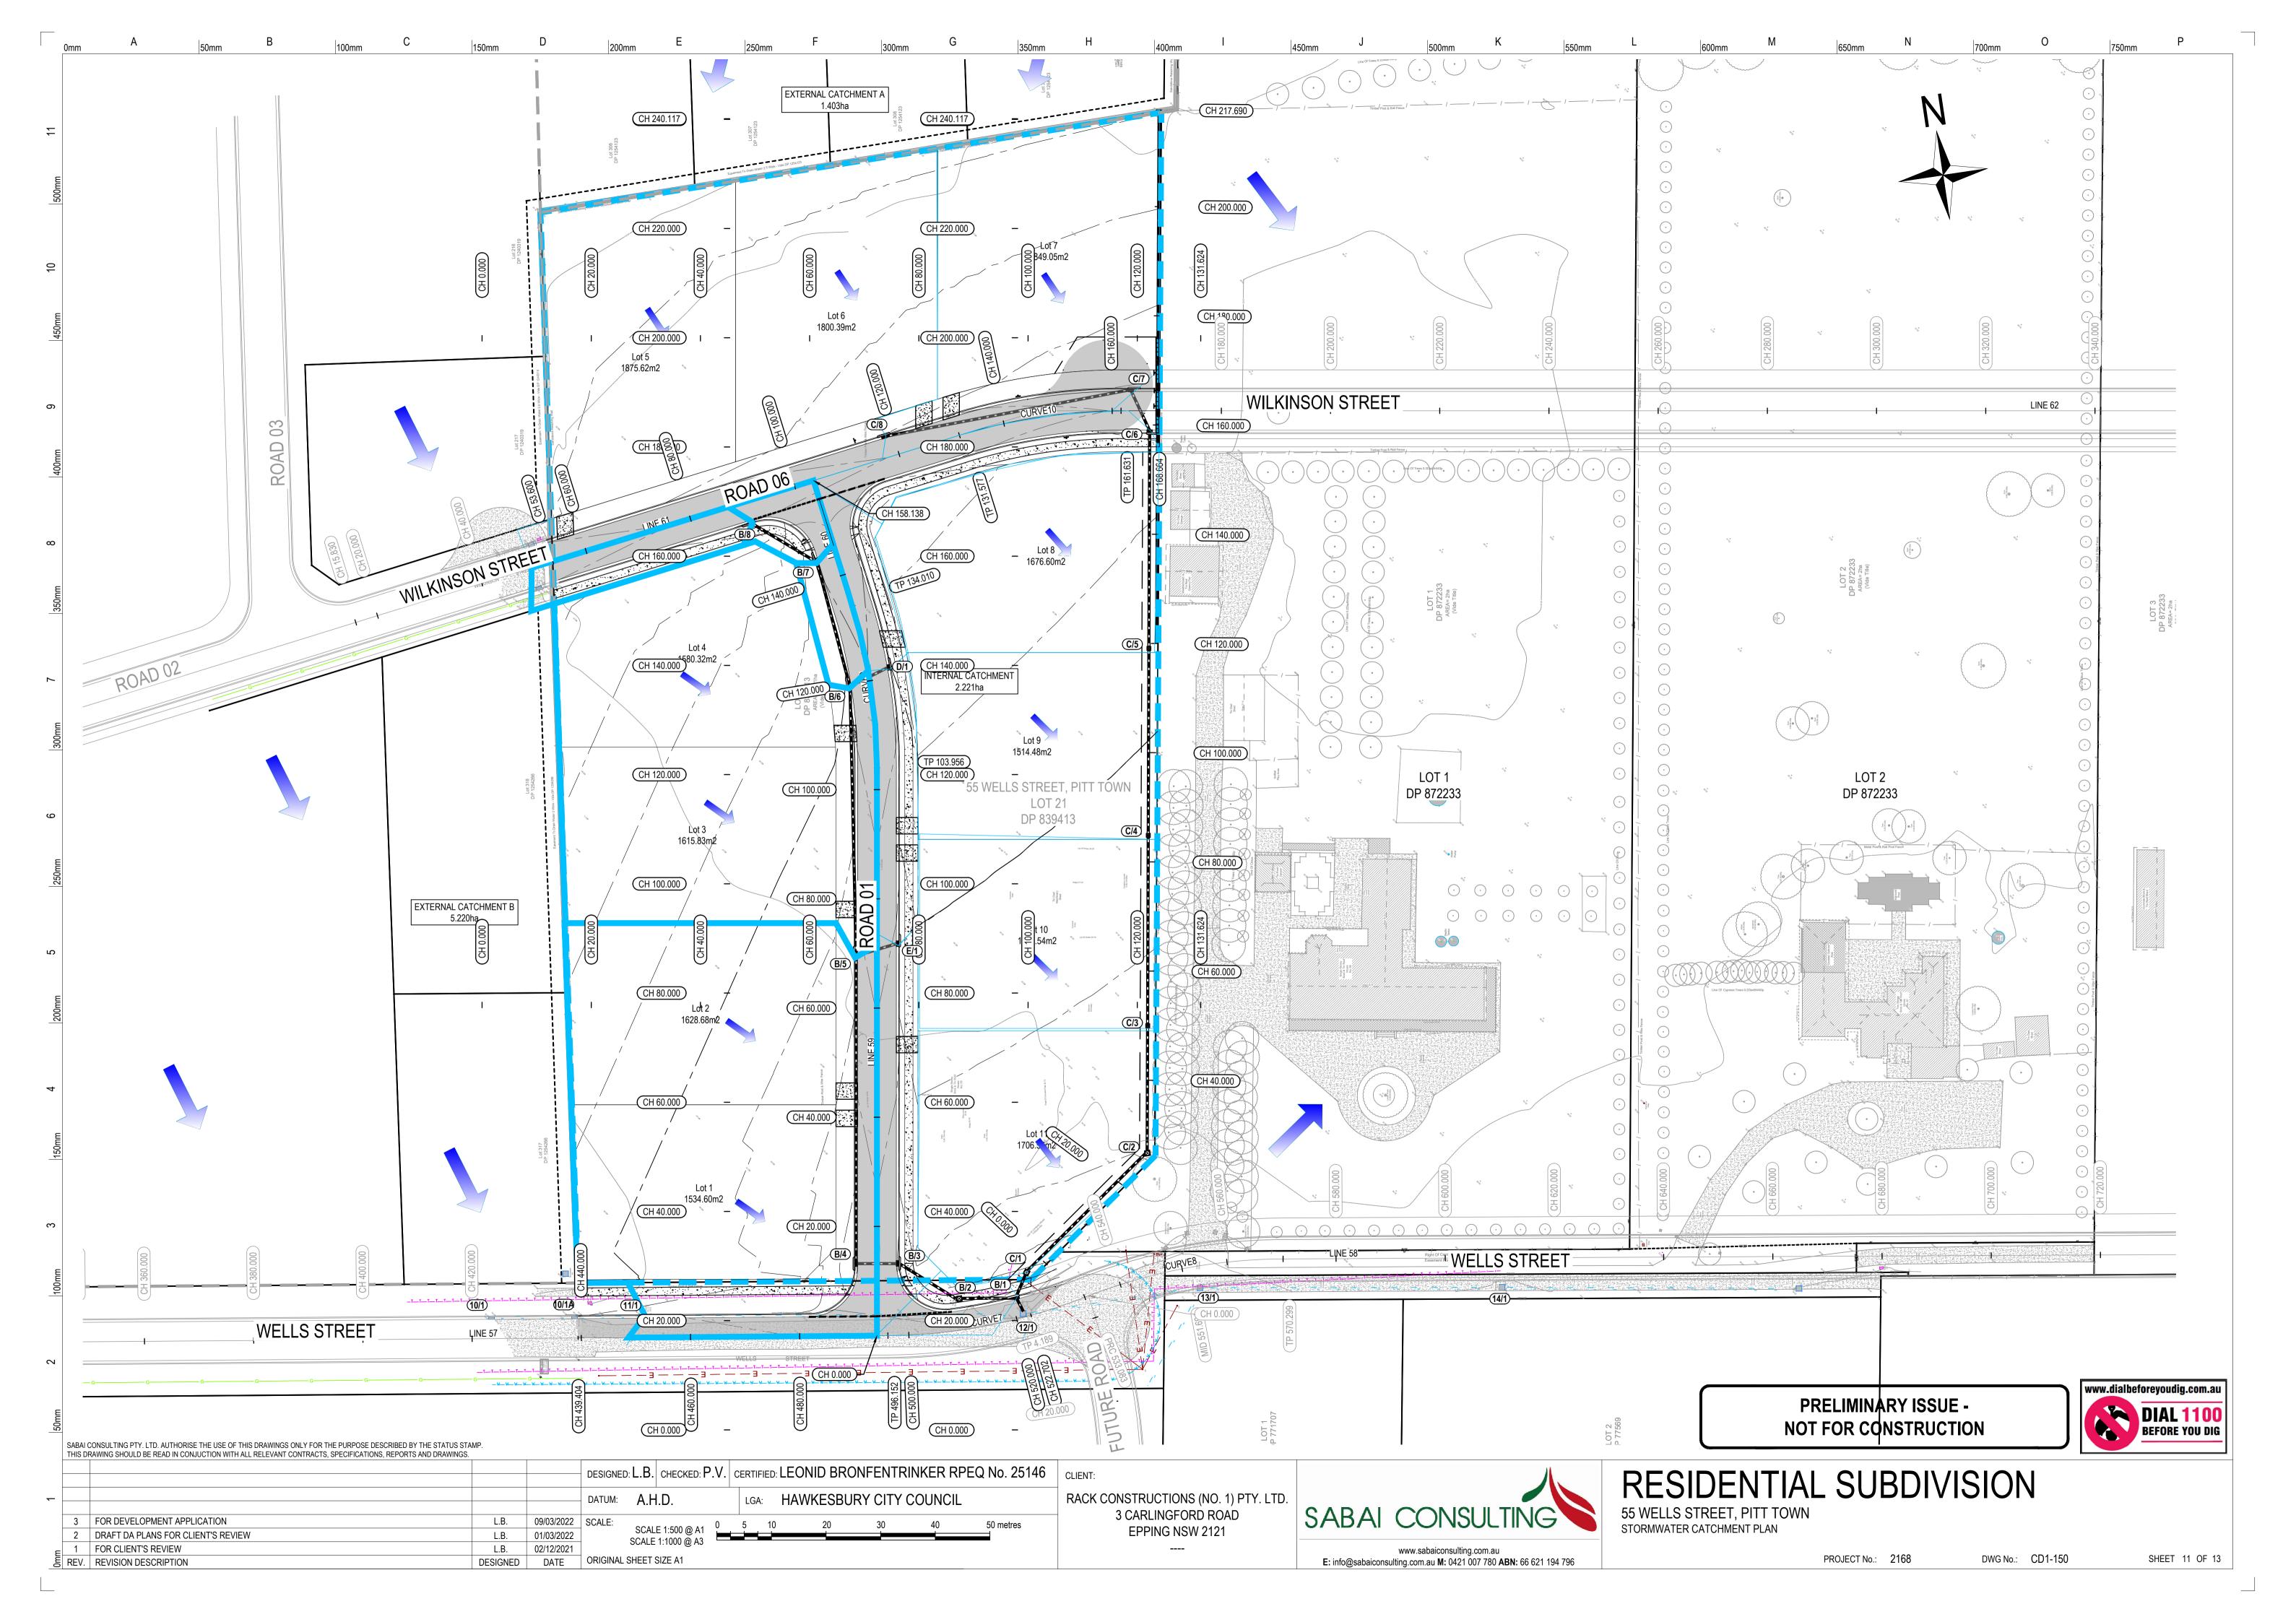
DESIGNED: L.B. CHECKED: P.V. CERTIFIED: LEONID BRONFENTRINKER RPEQ No. 25146 CLIENT: RACK CONSTRUCTIONS (NO. 1) PTY. LTD. LGA: HAWKESBURY CITY COUNCIL 3 CARLINGFORD ROAD **EPPING NSW 2121** SCALE 1:500 @ A1 SCALE 1:1000 @ A3





ROAD LONGITUDINAL SECTIONS - ROAD 01

PROJECT No.: 2168 DWG No.: CD1-142 SHEET 10 OF 13



REQUIRED AG. PIPE IN FILTER

SOCK AND BLUE METAL.

WRAP IN GEOTEXTILE FABRIC.

CONNECT TO APPROVED OUTLET F.S.L. ADD ADDITIONAL SANDSTONE BLOCK AND ORIENTATE FIRM NATURAL GROUND **EXISTING SURFACE** BOTTOM AS DETAILED FOR WALLS GREATER THAN A 1M 500 HIGH x 500 WIDE x 1000 LONG SANDSTONE BLOCKS HIGH (UP TO 1500 MAX.) SECTION A-A (RW1) INTER-ALLOTMENT STORMWATER PIPE TYPICAL BATTER SECTION - CH. 0 - 120 TYPICAL RETAINING WALL SECTION - CH. 120 - 218 Scale: N.T.S.

SCALE 1:25 @ A1 SCALE 1:50 @ A3

RACK CONSTRUCTIONS (NO. 1) PTY. LTD.

3 CARLINGFORD ROAD

**EPPING NSW 2121** 

SCALE 1:100 @ A1 SCALE 1:200 @ A3

SCALE 1:500 @ A1

SCALE 1:1000 @ A3

DATUM: A.H.D.

L.B. 09/03/2022 SCALE:

02/12/2021

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01/03/2022

DESIGNED DATE ORIGINAL SHEET SIZE A1

DESIGNED: L.B. CHECKED: P.V. CERTIFIED: LEONID BRONFENTRINKER RPEQ No. 25146 | CLIENT:

LGA: HAWKESBURY CITY COUNCIL


SABAI CONSULTING PTY. LTD. AUTHORISE THE USE OF THIS DRAWINGS ONLY FOR THE PURPOSE DESCRIBED BY THE STATUS STAMP. THIS DRAWING SHOULD BE READ IN CONJUCTION WITH ALL RELEVANT CONTRACTS, SPECIFICATIONS, REPORTS AND DRAWINGS.

FOR DEVELOPMENT APPLICATION

FOR CLIENT'S REVIEW

REV. REVISION DESCRIPTION

DRAFT DA PLANS FOR CLIENT'S REVIEW

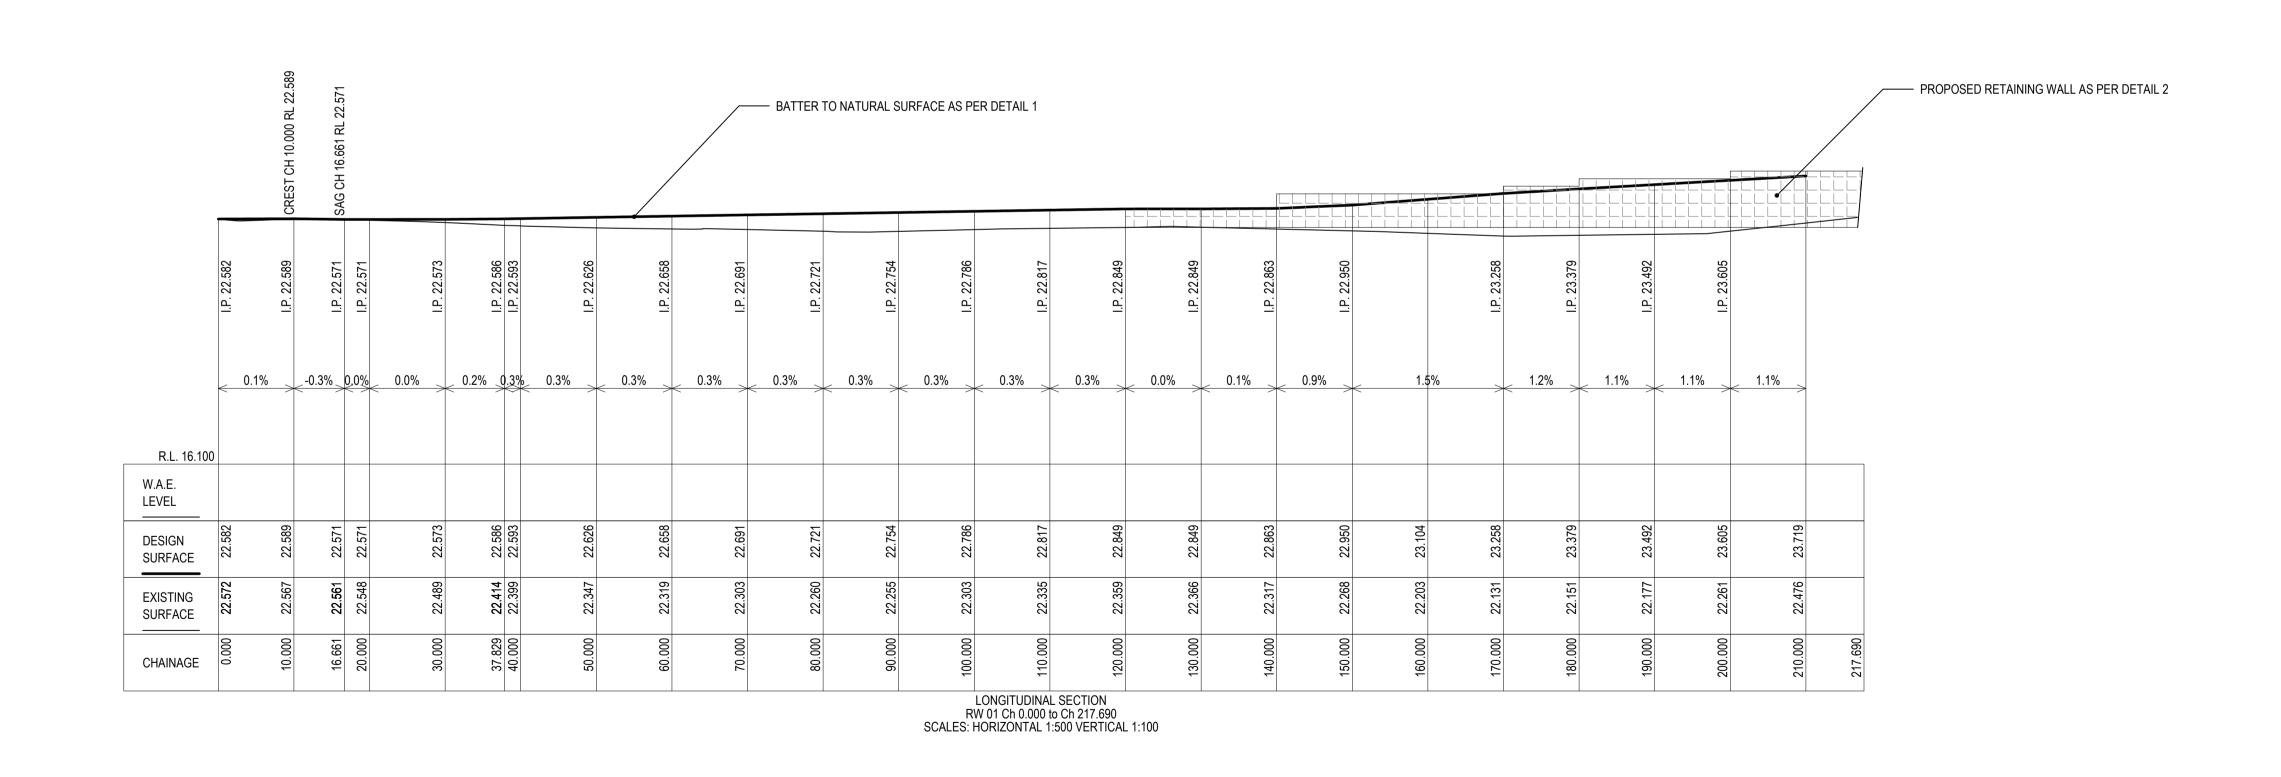

NOT FOR CONSTRUCTION

Scale: 1:25



RESIDENTIAL SUBDIVISION

PRELIMINARY ISSUE -

55 WELLS STREET, PITT TOWN RETAINING WALL LONGITUDINAL SECTIONS


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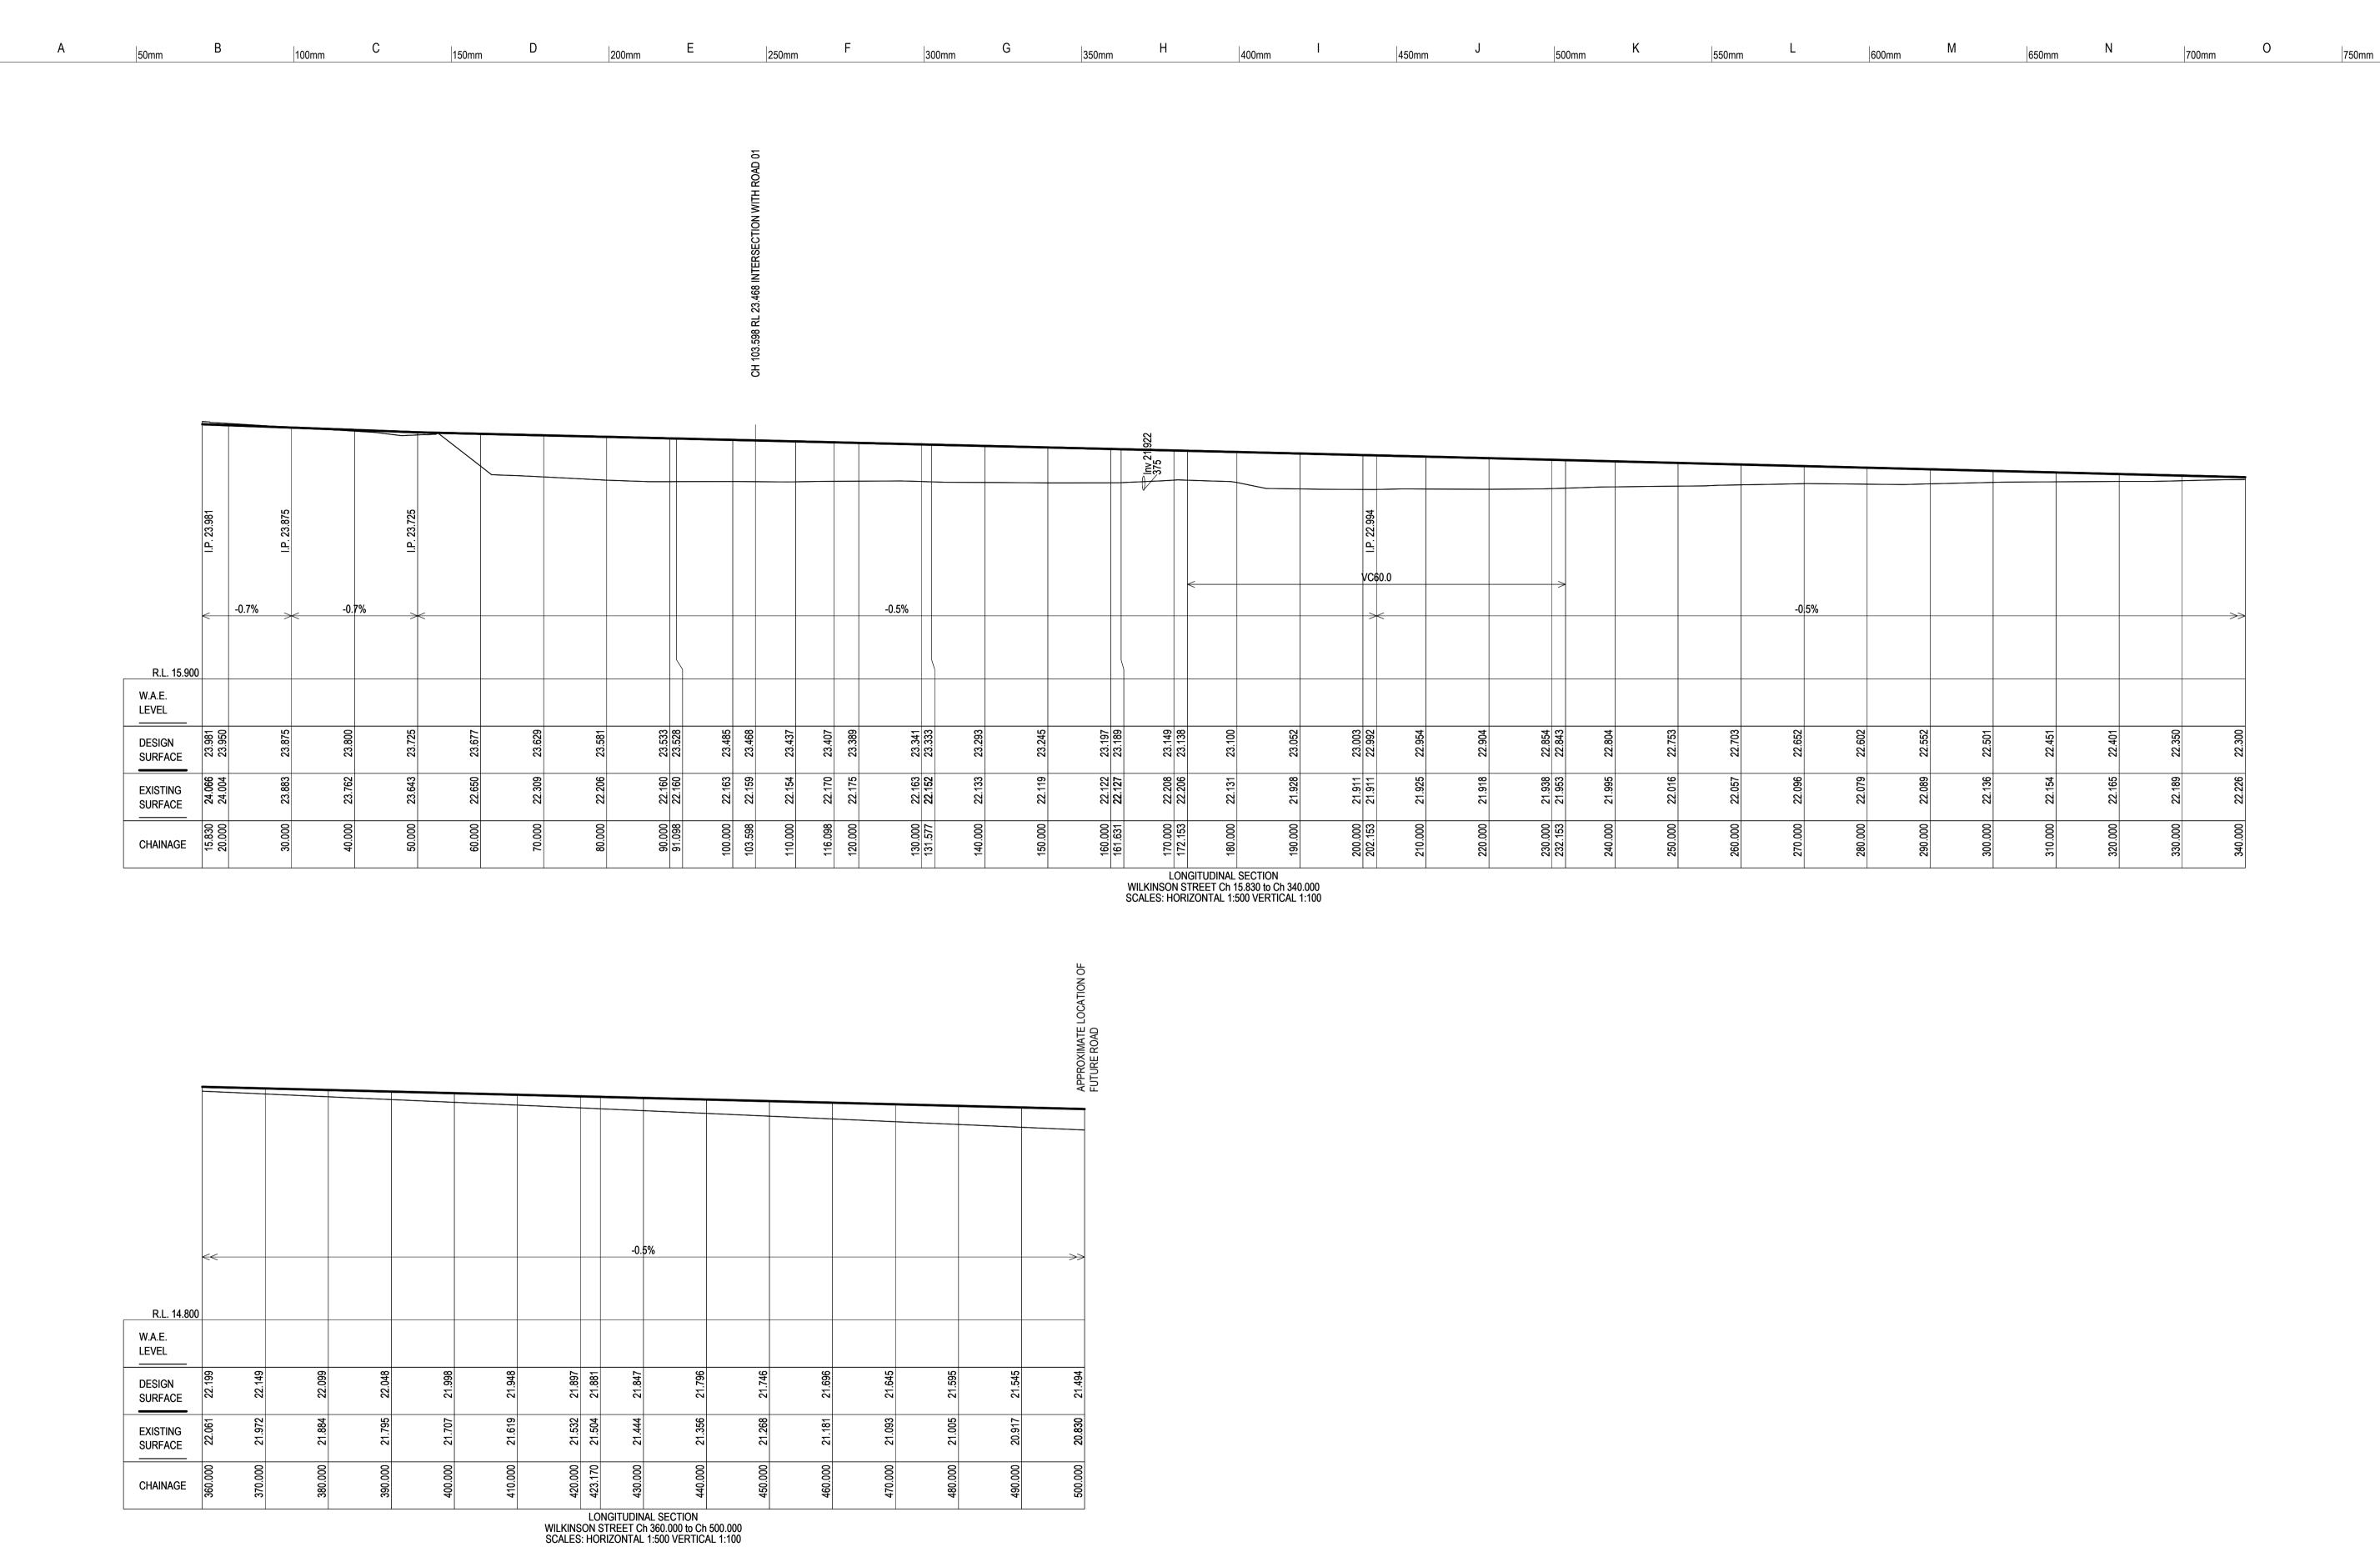
E: info@sabaiconsulting.com.au M: 0421 007 780 ABN: 66 621 194 796

PROJECT No.: 2168

DWG No.: CD1-161

SHEET 12 OF 13



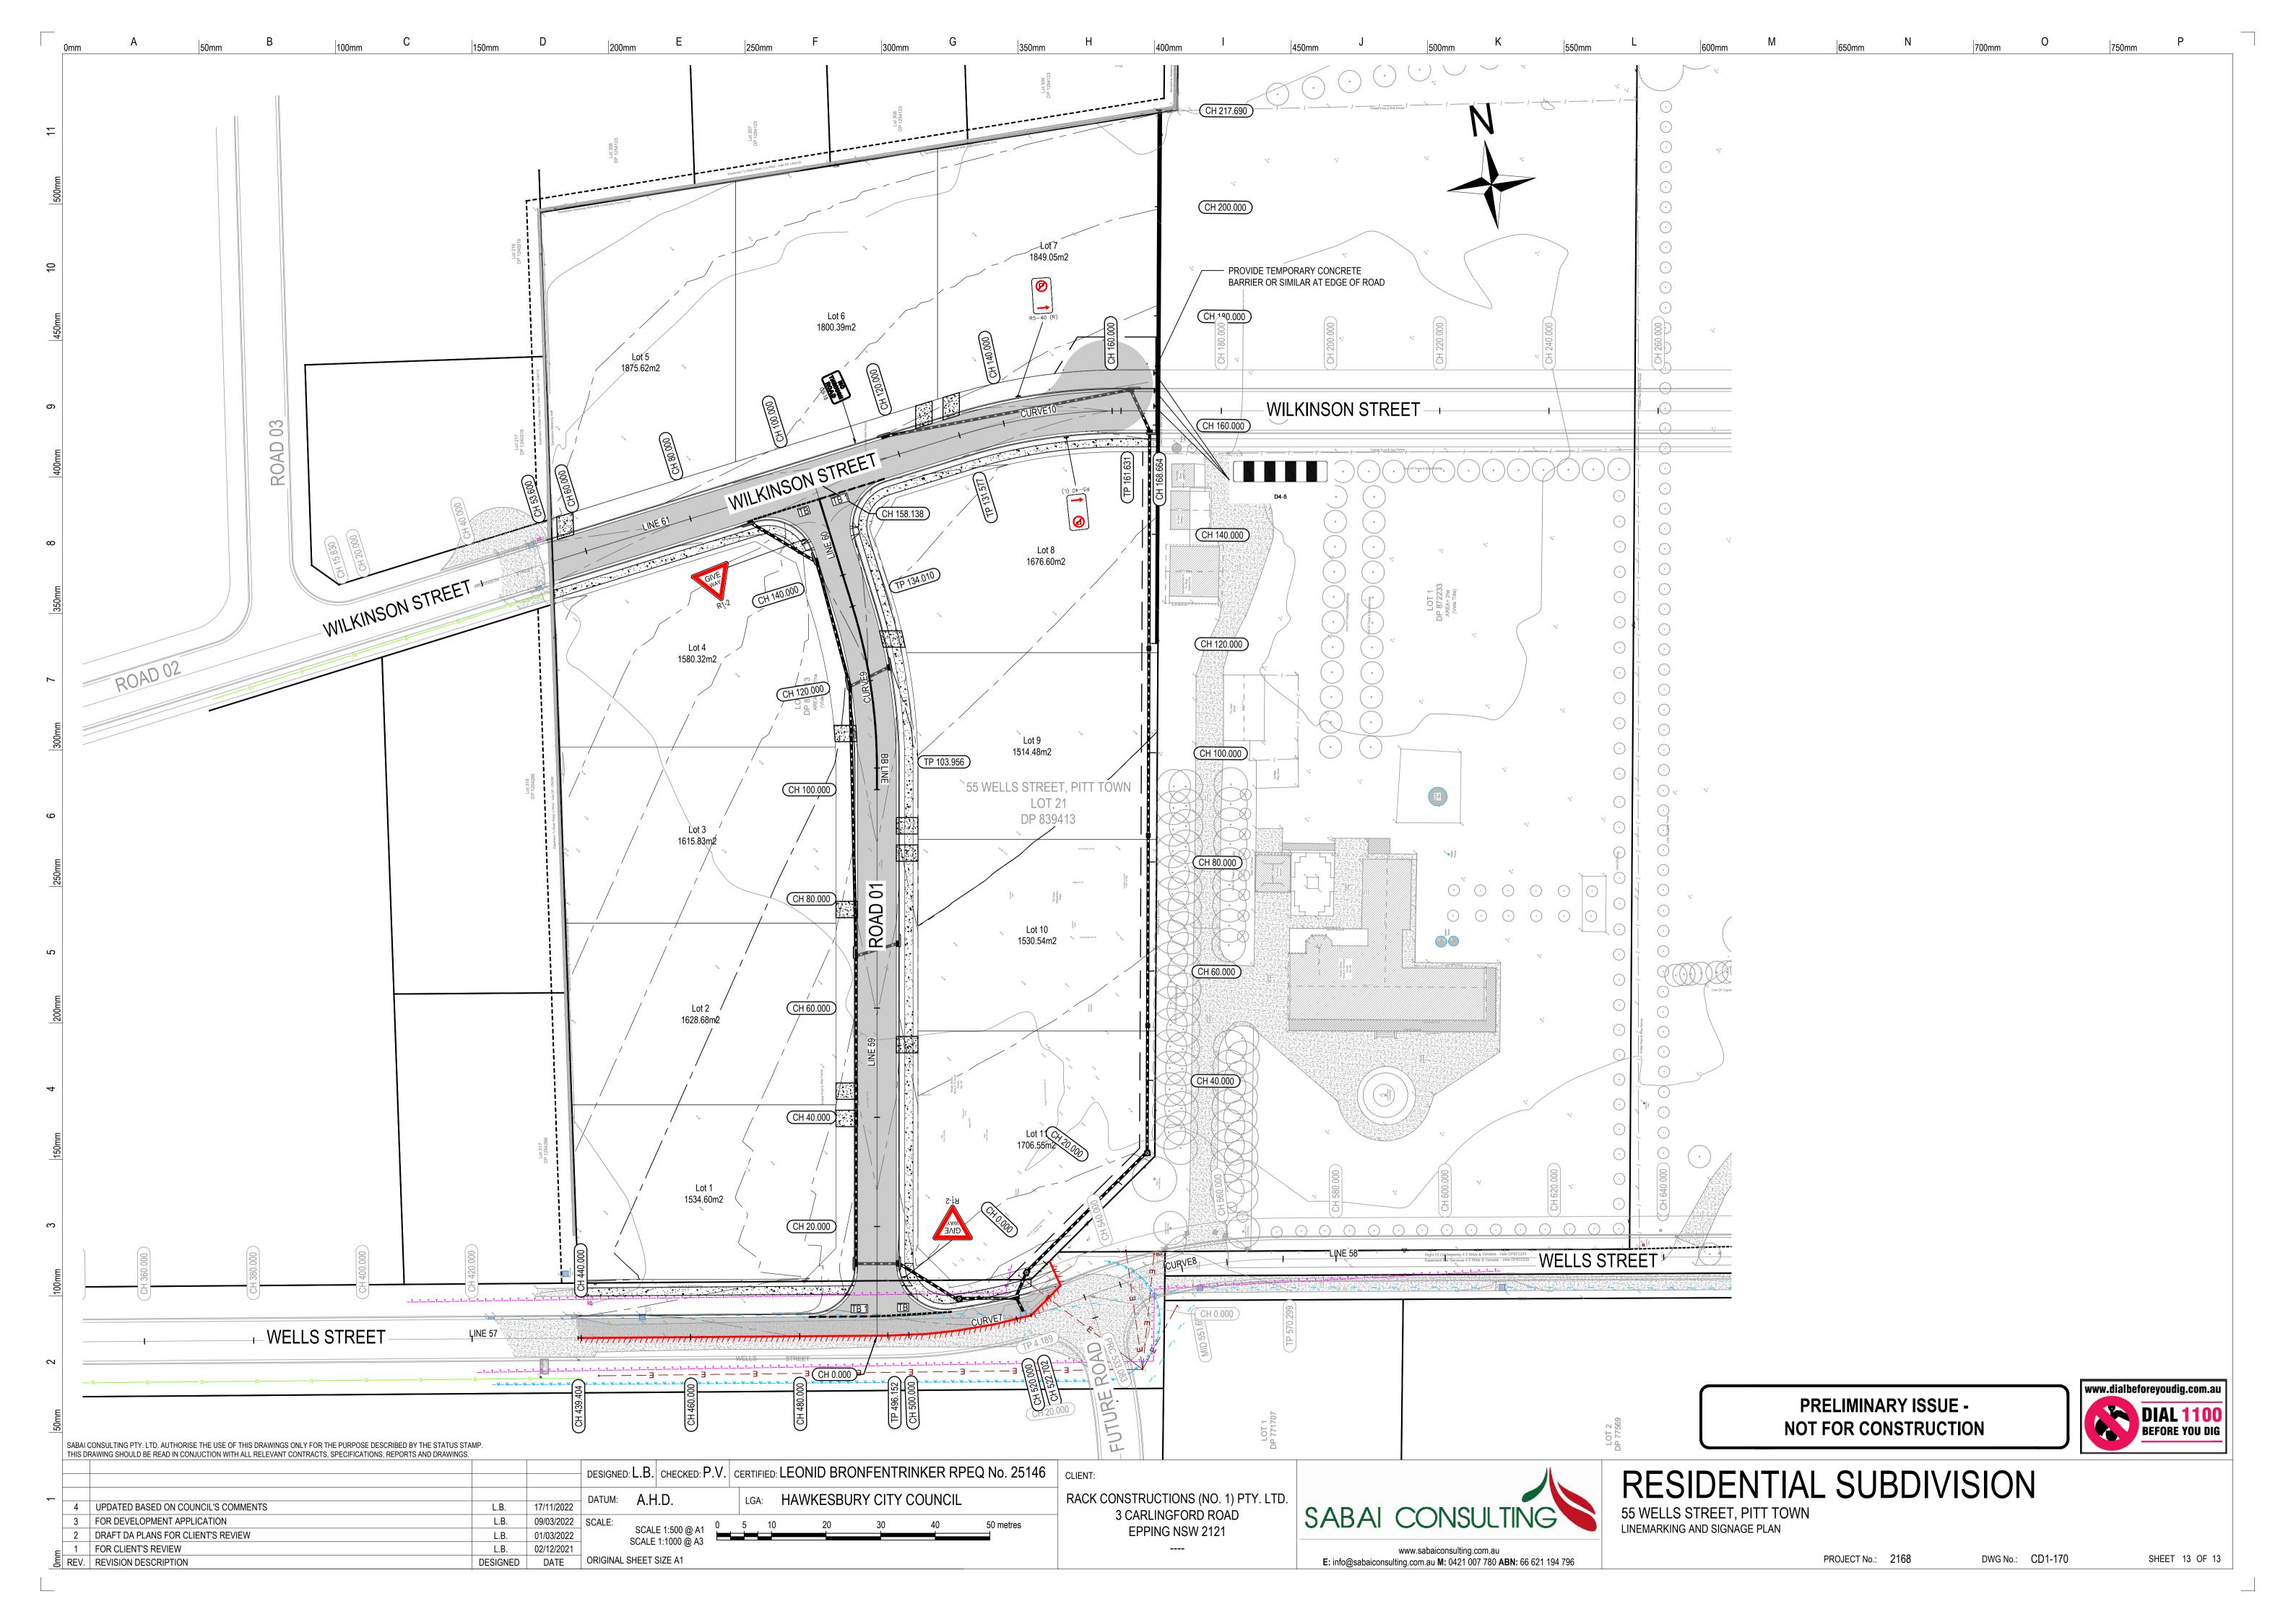

3 CARLINGFORD ROAD

**EPPING NSW 2121** 

SCALE 1:100 @ A1 SCALE 1:200 @ A3 DESIGNED: L.B. CHECKED: P.V. CERTIFIED: LEONID BRONFENTRINKER RPEQ No. 25146 CLIENT: RACK CONSTRUCTIONS (NO. 1) PTY. LTD. LGA: HAWKESBURY CITY COUNCIL DATUM: A.H.D.

SCALE 1:500 @ A1 0 5 10

SCALE 1:1000 @ A3

L.B. 17/11/2022

DESIGNED DATE ORIGINAL SHEET SIZE A1

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1 FOR INFORMATION

REV. REVISION DESCRIPTION

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WILKINSON STREET FUTURE EXTENSION LONGSECTION

PROJECT No.: 2168 DWG No.: SK-02


PRELIMINARY ISSUE -

NOT FOR CONSTRUCTION

SHEET 1 OF 1

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DIAL 1100
BEFORE YOU DIG

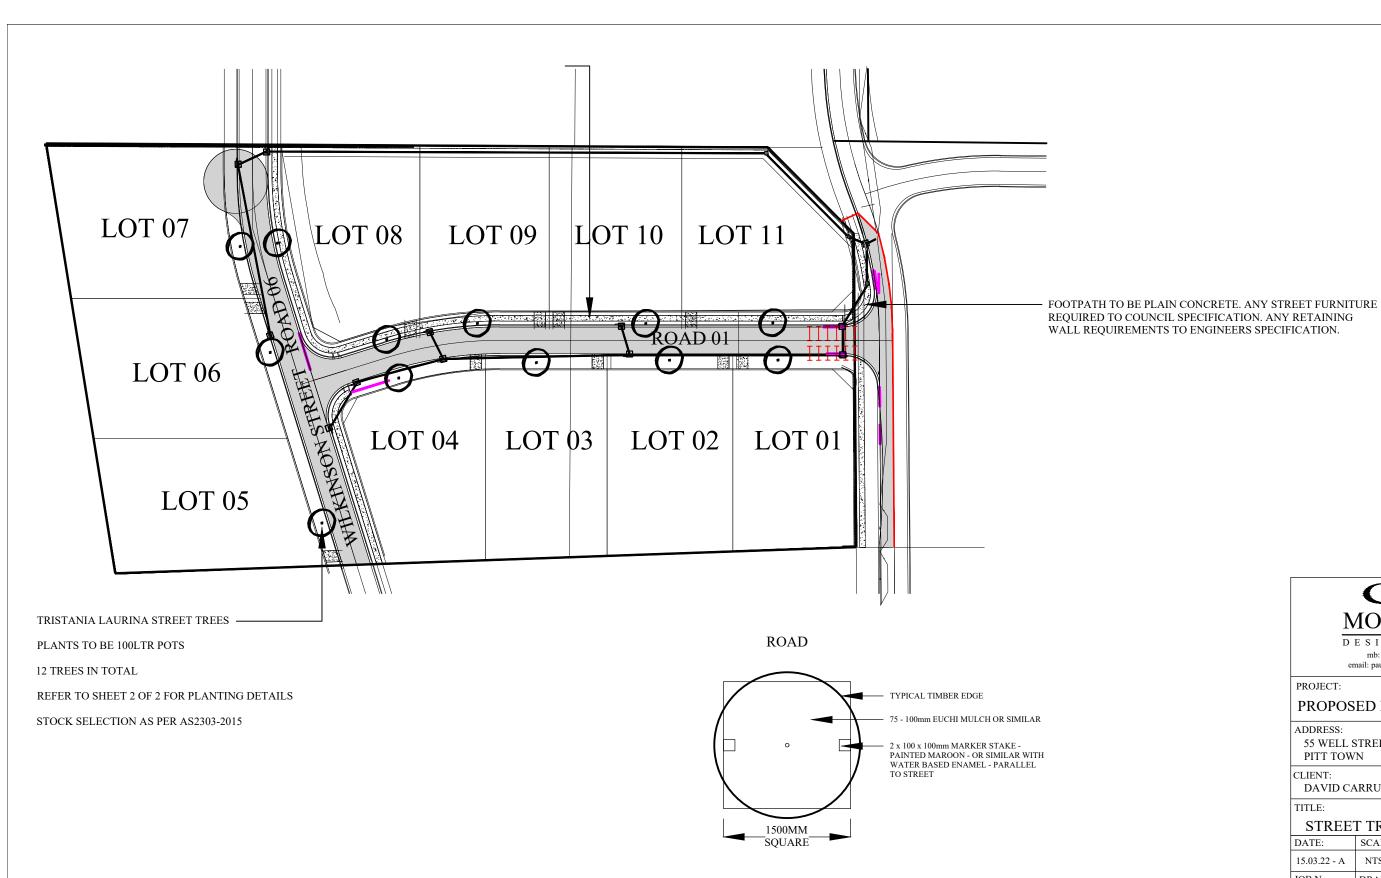

NOTE:- MONACO DESIGNS PL RESERVES THE RIGHT NOT TO UNDERTAKE NOR SUPPLY CERTIFICATION FOR OCCUPATION CERTIFICATE. NOTE:- TO AID COMPLIANCE WITH BASIX LEGISLATION, PLANTS (WHERE APPLICABLE) HAVE BEEN SELECTED FROM THE LOCAL CITY COUNCIL / SHIRE PLANT LISTS. NOTE: LOCATION OF SEWER MAINS / LINES, WATER PIPES, UNDERGROUND ELECTRICITY AND OTHER SERVICES MUST BE OBTAINED PRIOR TO COMMENCEMENT OF ANY WORK ON SITE. DIAL BEFORE YOU DIG 1100.

CONTRACTORS NOTE:- CALCULATED AREAS DETERMINED BY CAD AND HAVE BEEN ROUNDED UP FOR USE AS A GUIDE ONLY. ALLOW STANDARD PERCENTAGES FOR CUTTING AND WASTAGE. CONFIRM DIMENSIONS AND NUMBERS PRIOR TO QUOTING / ORDERING. COPYRIGHT:- THIS PLAN AND DESIGN IS THE PROPERTY OF MONACO DESIGNS PL. IT IS NOT TO BE COPIED OR REPRODUCED WITHOUT THE WRITTEN PERMISSION OF THE COMPANY. REPRODUCTION PARTLY OR IN FULL CONSTITUTES AN INFRINGEMENT OF COPYRIGHT. FULL TERMS AND CONDITIONS CAN BE OBTAINED FROM MONACO DESIGNS WEBSITE, OR UPON REQUEST. THIS PLAN MAY ONLY BE UTILISED FOR ITS INTENDED PURPOSE ONCE PAYMENT HAS BEEN RECEIVED IN FULL, OR AS PER OUR LETTER OF AGREEMENT. UNAUTHORISED USAGE, REPRODUCTION OR STORAGE SHALL BE TAKEN AS AN ACCEPTANCE OF A USAGE FEE OF \$2200 PER PLAN / SHEET OR PART THEREOF FOR EACH AND EVERY USE.





DESIGNS mb: 0409123200 email: paul@monaco.net.au

PROPOSED DEVELOPMENT

ADDRESS:

55 WELL STREET, PITT TOWN

CLIENT:

DAVID CARRUTHERS

TITLE: DA


STREET TREE PLANTING


DATE: SCALE: SHEET No: 15.03.22 - A NTS - A3 1 of 2 JOB No. DRAWN: 6132

> TREE REPORTS LANDSCAPE PLANS VEGETATION MANAGEMENT PLANS

#### **GENERAL NOTES:-**


- \* LANDSCAPE CONTRACTOR TO CHECK DA CONDITIONS AND STAMPED LANDSCAPE PLAN BEFORE COMMENCING WORKS TO ENSURE NO ADDITIONS / AMENDMENTS TO PLAN.
- \* GARDEN BEDS IN OSD BASIN TO CONSIST OF NON FLOATABLE DECORATIVE GRAVEL.
- \* REFER TO HYDRAULICS ENGINEERS PLAN FOR OSD DETAILS / FINAL LEVELS.
- \* MULCHED PLANTING BEDS TO BE A MINIMUM DEPTH OF 75MM AS SELECTED.
- \* CONTRACTORS RESPONSIBILITY TO CHECK AND ADJUST SOIL pH AS REQUIRED. \* PROVIDE TIMBER EDGE AS A MINIMUM BENEATH FENCING / GATES TO DEFINE TURF AND GARDEN BEDS / PATHWAYS. EDGING TO BE PROVIDED TO ALL AREAS WHERE DIFFERING
- MATERIALS MEET, ie TURF / GARDEN, TURF / GRAVEL PATH ETC.
- \* WEED MAT BENEATH GRAVEL PATHWAYS REQUIRED TO LIMIT MUD TRACKING. \* PREMIUM ORGANIC GARDEN MIX TO BE USED.
- \* ALL PLANTS TO BE HEALTHY AND VIGOROUS.
- \* CONTRACTOR TO MAKE GOOD TURF ON NATURE STRIP POST CONSTRUCTION.
- \* DO NOT SCALE ARCHITECTURAL SETOUT FROM LANDSCAPE DRAWING.
- \* EXISTING TREE SPREAD APPROXIMATE ONLY. REFER TO TREE REPORT WHEN APPLICABLE.
- \* SITE SURVEY PROVIDED BY OTHERS.
- \* BUFFALO TURF PREFERRED OVER KIKUYU.

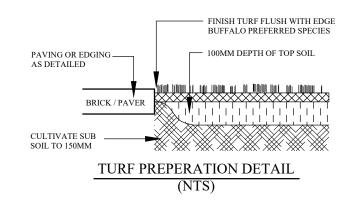

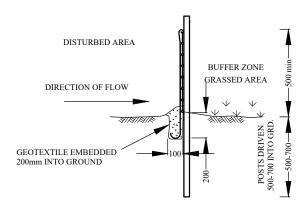


#### SEDIMENT BARRIER (NTS)

(PROVIDE ON ALL DOWN HILL SLOPES - UNLESS STATED OTHERWISE)

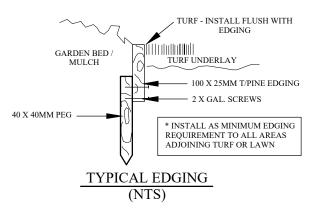

#### TYPICAL PLANT SELECTION CRITERIA - AS2303-2015

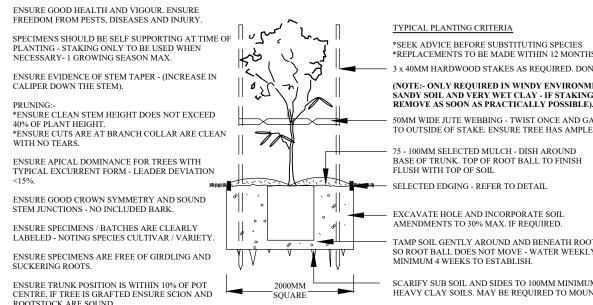

45-75LTR TYPICAL PLANTING

TYPICAL PLANTING CRITERIA

\*SEEK ADVICE BEFORE SUBSTITUTING SPECIES
\*REPLACEMENTS TO BE MADE WITHIN 12 MONTHS 3 x 40MM HARDWOOD STAKES AS REQUIRED. DON'T PIERCE ROOT BALL

(NOTE:- ONLY REQUIRED IN WINDY ENVIRONMENTS, VERY SANDY SOIL AND VERY WET CLAY - IF STAKING REQUIRED -

50MM WIDE JUTE WEBBING - TWIST ONCE AND GAL. STAPLE TO OUTSIDE OF STAKE, ENSURE TREE HAS AMPLE MOVEMENT

75 - 100MM SELECTED MULCH - DISH AROUND

SELECTED EDGING - REFER TO DETAIL

EXCAVATE HOLE AND INCORPORATE SOIL AMENDMENTS TO 30% MAX. IF REQUIRED.


TAMP SOIL GENTLY AROUND AND BENEATH ROOT BALL. SO ROOT BALL DOES NOT MOVE - WATER WEEKLY FOR MINIMUM 4 WEEKS TO ESTABLISH

SCARIFY SUB SOIL AND SIDES TO 100MM MINIMUM IN

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(IF NO ARBORIST REPORT REQUIRED)

PROJECT: PROPOSED DEVELOPMENT

mb: 0409123200

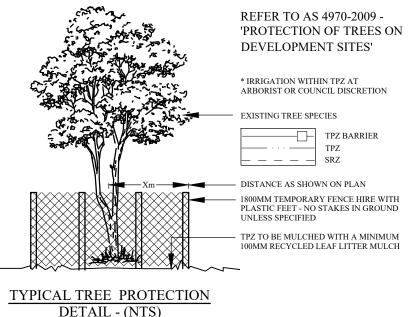email: paul@monaco.net.au

55 WELL STREET, PITT TOWN

CLIENT: DAVID CARRUTHERS

TITLE:

LANDSCAPE DETAILS

SCALE: DATE: SHEET No: 15.03.22 - A NTS - A3 OF JOB No. DRAWN: 6132 P MONACO

> TREE REPORTS LANDSCAPE PLANS VEGETATION MANAGEMENT PLANS