

Attachment 2 to Item 2.1.1.

Architectural Plans

Date of meeting: 21 March 2024 Location: By audio-visual link Time: 10:00 A.M.

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| | | | | | | | | _ | 6 ELEVATIONS |
| | | | | | | | | | 5 ELEVATIONS |
| | | | | | | | | | 4 FLOOR PLAN 3 SITE PLAN |
| | | | | | | | | | 2 SITE PLAN - LOCATION PLAN |
| | | | | | | | | ⊢ | 1 COVER SHEET |
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| NOTE: | | CLIENT: RSL | JOB No: Nactoci O1 | © COPYRIGHT | | | | | |
| ALL DIMENSIONS ARE IN | | RSL - | Nastasi 01 | | NASTASI & ASSO Consulting Civil & Structural Eng | CIATES | | | |
| MILLIMETERS. ALL DIMENSIONS ARE FRAME TO FRAME. DO NOT SCALE OFF PLANS. | | SITE ADDRESS: | DRAWN: DATE: Nastasi 16.12.16 | Rev: | Consulting Civil & Structural Eng | o o d | 04 | | |
| | STANDARD | Lot 1 in DP 556829. No 361, George Street, | CHECKED: SHEET: 1 | A | Ph. (02) 9607 2864 M. 041 | 9 041 4 | | | |
| | SCALE: NTS | Windsor. NSW. 2756. | Council App | | Unit 5, 1-3 Whyai | ra Place, Pres | stons | | |
| Document Set ID. გევიყევ | /2023 | | • | 1 | | | | - | |

LEGEND

| BENCH MARK | A |
|---------------------|----------|
| ELECTRIC LIGHT POLE | ● ELP |

LOT

D.P: 556829

L.G.A: HAWKESBURY



PLANSITE

SCALE 1:800M

<u>NOTES</u>

- Bearings and distances are by Title and/or Deed only.
 This detail survey is not a "survey" as defined by the Surveyors Act,1929.
 If any construction is planned it would be advisable to carry out further survey work to determine the boundary dimensions.
- Survey work to determine the boundary dimensions.


 Relationship of improvements to boundaries is diagrammatic only. Where offsets are critical they should be confirmed by further survey.

 Contours shown depict the topography, except at spot levels shown they do not represent the exact level at any particular point.

 Services shown hereon have been determined from visual evidence only. Prior to any demolition, excavation or construction on the site the relevant of the probability behalf the controlled to possibility debuild in the controlled of the controlled prior to the probability and the controlled or the probability debuild.
- authority should be contacted to establish detailed location and depth.

 Australian Height Datum was established from SSM 168755 RL 69.056

 Tree locations are accurate to +/- 0.30m
- The information is only to be used at a scale accuracy of 1:200.

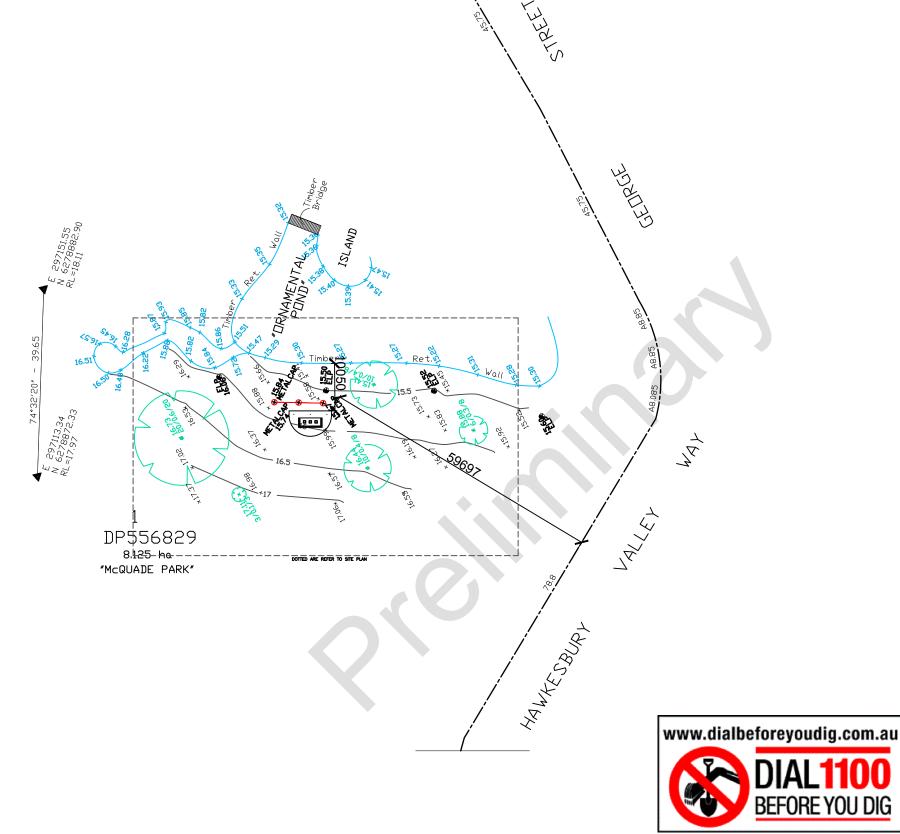

SITE INDUCTION

Before entering site please review and make yourself familiar with Emergency Contacts. Site Specific Hazards and the Site Specific Induction information that is located on the Site Induction Sign. If you have any trouble understanding this instruction, contact the Site Supervisor or **Emergency Contact Number located on the**

SITE SPECIFIC HAZARDS


- * OVERHEAD POWERLINES
- * NO STREET PARKING

BEFORE YOU DIG


* LIMITED SPACE FOR MATERIAL STOCK PILE

CLIENT: NOTE: ALL DIMENSIONS ARE IN Nastasi 01 RSL MILLIMETERS. ALL DIMENSIONS DATE DRAWN: ARE FRAME TO FRAME. DO NOT Nastasi 16.12.16 SITE ADDRESS: SCALE OFF PLANS. Lot 1 in DP 556829. CHECKED: **STANDARD** No 361, George Street, Council App Windsor. NSW. 2756.



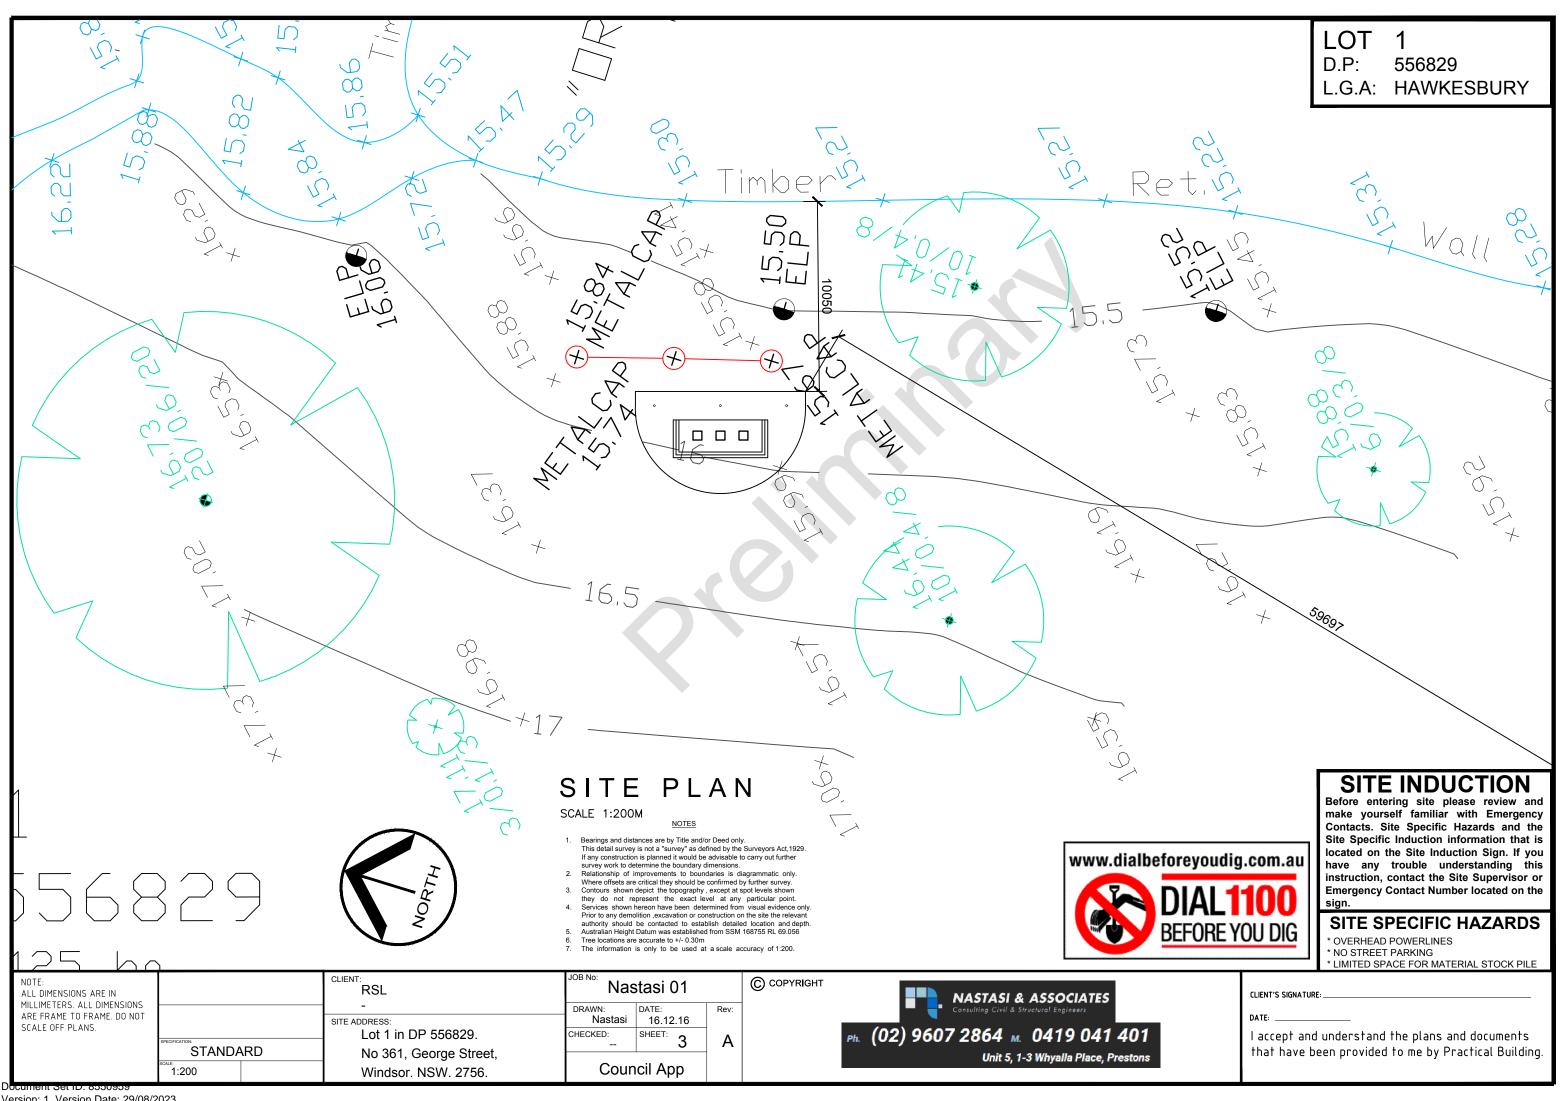

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37.22m2 Area of Structure

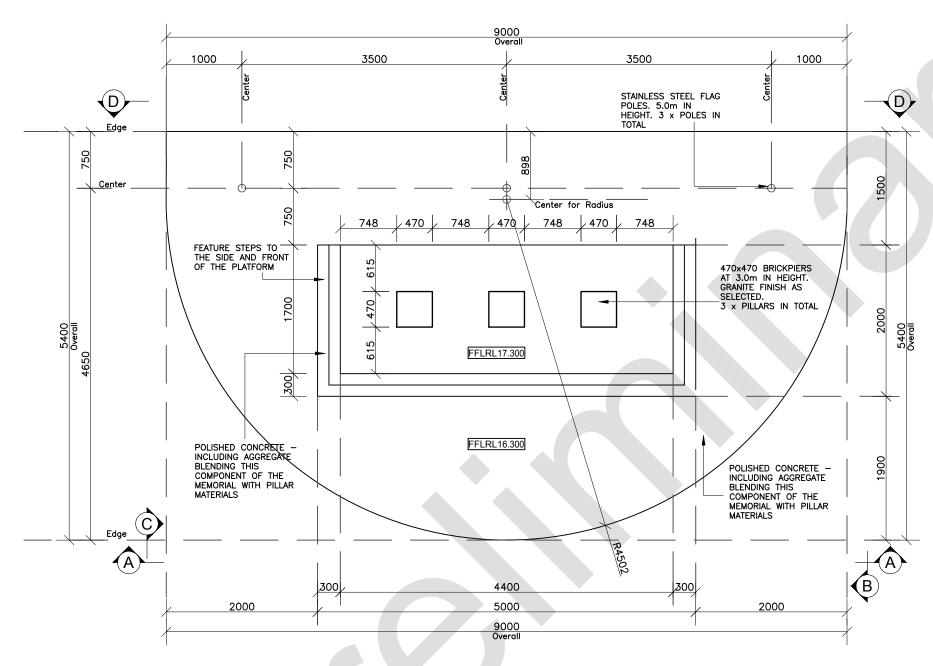


| NOTE: ALL DIMENSIONS ARE IN | | CLIENT: RSL | JOB No: Nas | stasi 01 | | © COPYRIGHT | |
|---|----------|-------------------------|-------------|----------|------|-------------|--------------|
| MILLIMETERS. ALL DIMENSIONS | | - | DRAWN: | DATE: | Rev: | | |
| ARE FRAME TO FRAME. DO NOT SCALE OFF PLANS. | | SITE ADDRESS: | Nastasi | 16.12.16 | | | |
| SCALE UFF PLANS. | | Lot 1 in DP 556829. | CHECKED: | SHEET: | ^ | Ph (02 | Ph. (02) 960 |
| | STANDARD | No 361, George Street, | | 4 | А | | (32) 233 |
| is a second | SCALE: | INO 301, George Street, | | | | | |
| | 1:50 | Windsor. NSW. 2756. | Cour | ncil App | | | |




CLIENT'S SIGNATURE:

DATE:

I accept and understand the plans and documents that have been provided to me by Practical Building.

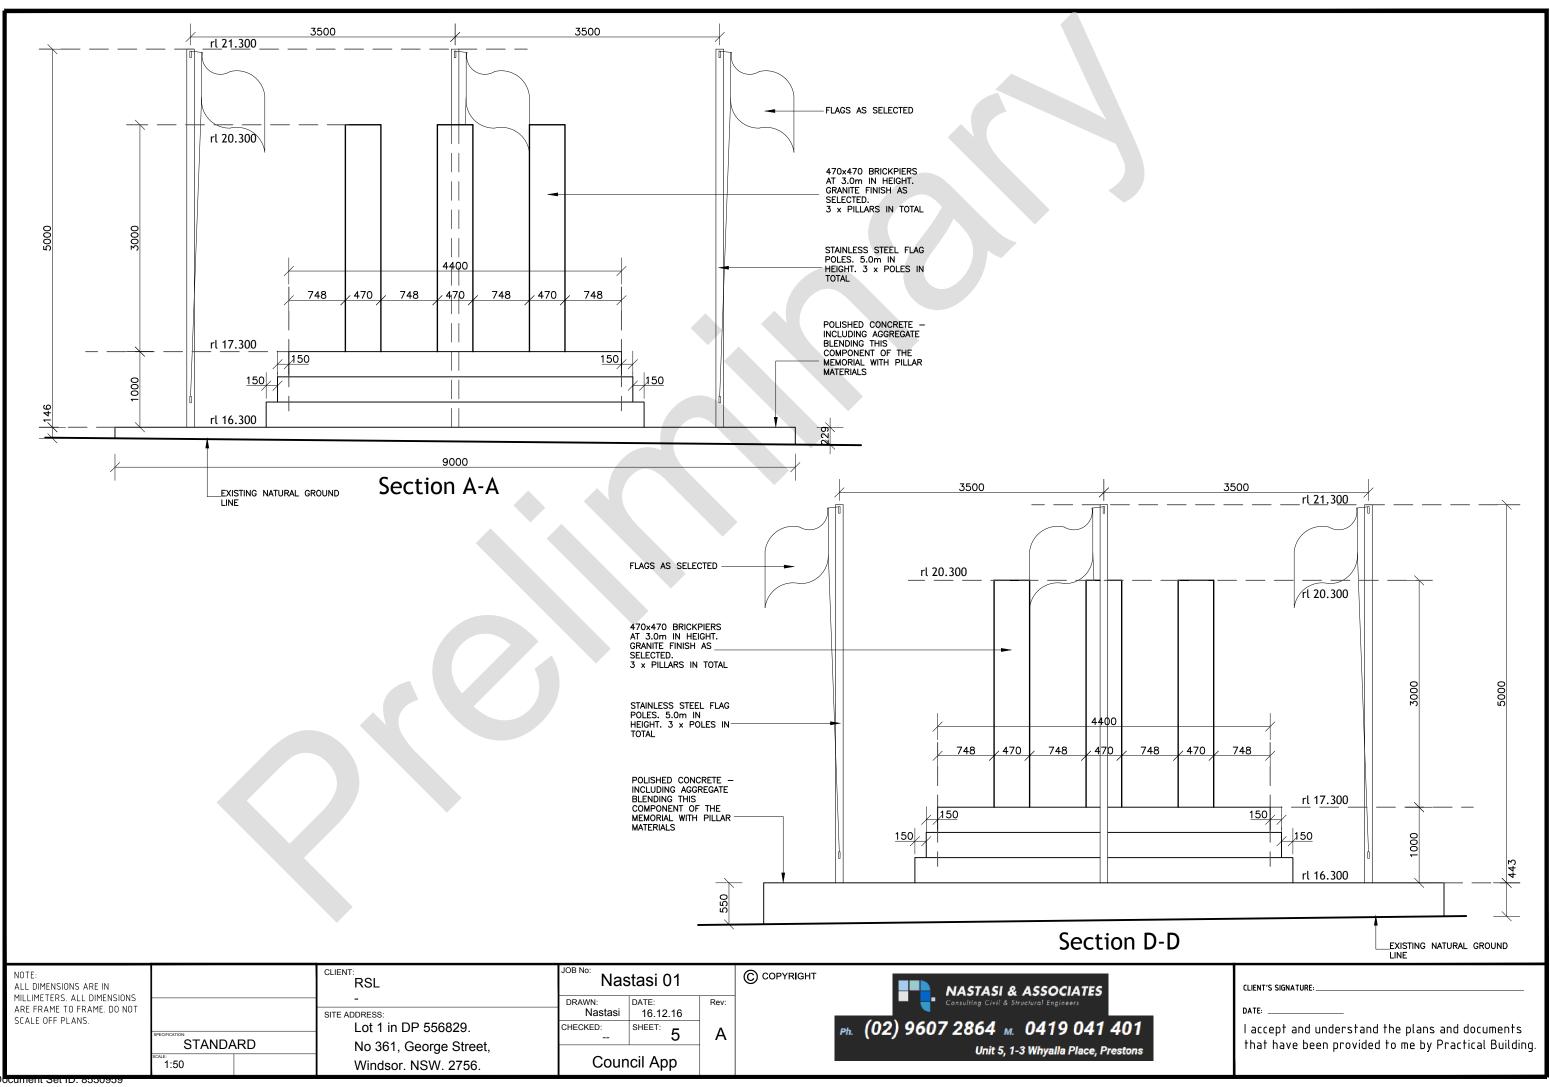

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PROPOSED NEW WAR MEMORIAL STRUCTURE McQUADE PARK, 361 GEORGE STREET, WINDSOR.

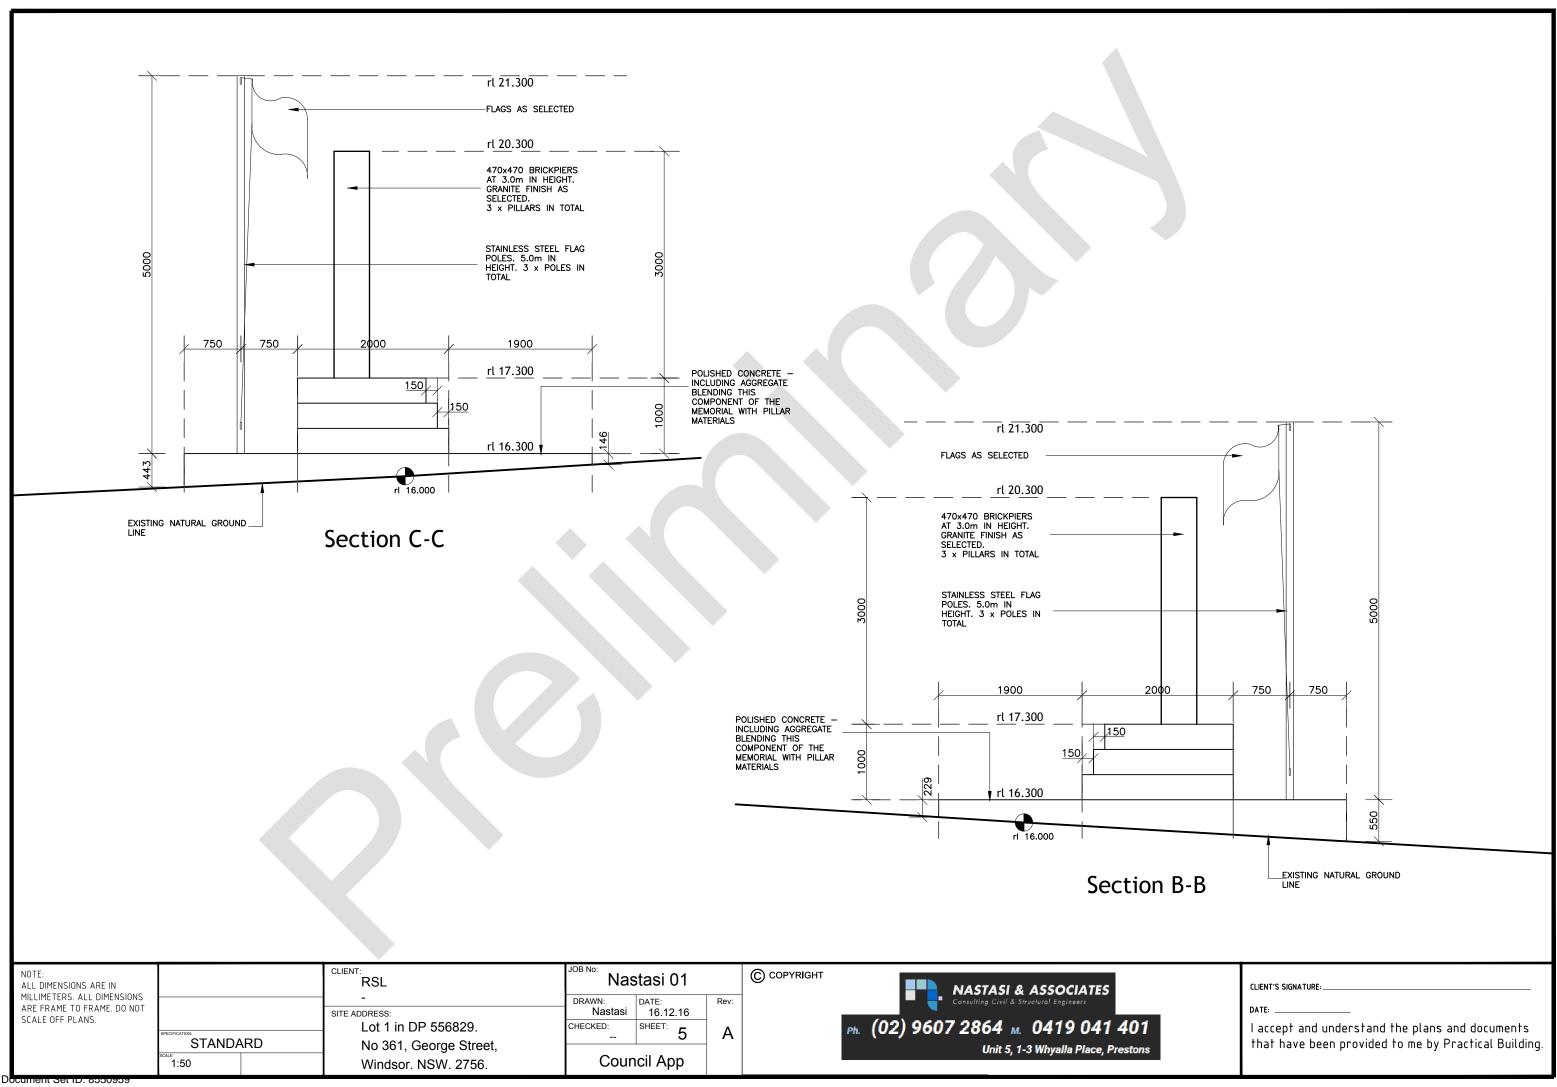- GENERAL

 1. ALL MATERIALS AND WORKMANSHIP TO BE IN ACCORDANCE WITH THE RELEVANT AND CURRENT S.A.A. CODES AND WITH THE BY-LAWS AND GROWNANCES OF THE RELEVANT BUILDING AUTHORITIES.

 2. SETTING-OUT DIMENSIONS AND SIZES OF STRUCTURAL MEMBERS NOT TO BE OBTAINED BY SCALING THE STRUCTURAL DRAWINGS. ANY SETTING-OUT DIMENSIONS SHOWN ON THE STRUCTURAL DRAWINGS OF THE STRUCTURAL DRAWINGS OF THE SUPERINTENDENT BEFORE CONSTRUCTION COMMENCES. REFER ANY DISCREPANCY TO THE SUPERINTENDENT BEFORE PROCEEDING WITH THE WORK.

 3. DURING CONSTRUCTION ITS THE CONTRACTOR'S RESPONSIBILITY TO ENSURE THAT THE STRUCTURE IS MAINTAINED IN A SAFE AND STABLE CONDITION AND NO PART IS OVERSTRESSED. TEMPORARY BRACING TO BE PROVIDED BY THE CONTRACTOR AS REQUIRED TO KEEP THE WORKS AND EXCAVATIONS STABLE AT ALL TIMES.

 4. UNLESS NOTED DITERWISE, ALL LEVELS ARE IN METRES AND ALL DIMENSIONS ARE IN MILLEMETES.

 5. THE STRUCTURAL COMPONENTS DETAILED ON THESE DRAWINGS HAVE BEEN DESIGNED IN ACCORDANCE WITH THE RELEVANT S.A.A. CODES AND BUILDING CODE OF AUSTRALIA.

 6. WIND LOADING HAS BEFOR ETERMINED IN ACCORDANCE WITH AS 1170.2 RASED UPON A BASIC WIND

- WIND LOADING HAS BEEN DETERMINED IN ACCORDANCE WITH AS 1170.2 BASED UPON A BASIC WIND VELOCITY OF 46m/s (Va) AND TERRAIN CATEGORY 3.
- VELULITY UP 46M/S IVAJ AND TERRAIN CATEGORY 3.

 EARTHOUAKE LOADING HAS BEEN DETERMINED IN ACCORDANCE WITH AS 1170.4

 ALL MATERIALS AND WORKMANSHIP SYALL BE IN ACCORDANCE WITH THE CURRENT CODES OF PRACTICE
 EXCEPT WHERE VARIED BY THE SPECIFICATION AND/OR DRAWINGS.

 AS 3600 CONCRETE STRUCTURES CODE
 AS 4671 STEEL REINFORCING MATERIALS
 AS 1020 STEEL REINFORCING BARS FOR CONCRETE
 AS 2700. MASSINGLY CORP.

- AS 3700 MASDNRY CODE

FOUNDATIONS

- FOOTINGS HAVE BEEN DESIGNED FOR AN ALLOWABLE BEARING INTENSITY OF 100kPa. ON NATURAL GROUND, TO BE CONFIRMED ON SITE FOUNDATION MATERIAL TO BE APPROVED FOR THIS PRESSURE BY THE SUPERINTENDENT AND BUILDING AUTHORITY BEFORE REINFORCEMENT AND/OR CONCRETE ARE PLACED.

 FOOTINGS TO BE LOCATED CENTRALLY UNDER WALLS AND COLUMNS U.M.O.

 BLINDING CONCRETE TO BE PLACED ON THE SAME DAY AS THE FINAL EXCAVATION TO THE

- BLINDING URRELET OF BEACED OF THE SAME DATAS THE FINAL EXCAVATION TO THE
 FOUNDATION DESIGN LEVEL.

 FOOTING LEVELS, WIERE SHOWN, ARE ESTIMATES ONLY AND WILL BE ESTABLISHED DURING
 SITE INSPECTION.
- SITE INSPECTION.
 UNLESS OTHERWISE APPROVED BY THE SUPERINTENDENT/ENGINEER THE LIMITATIONS
 OF EXCAVATIONS NEAR FOOTINGS SHALL BE AS FOLLOWS:-



. 7. SUB GRADE AND SUB BASE FOR SLABS ON GROUND SHALL COMPLY WITH THE FOLLOWING:



BASE SHALL BE APPROVED WELL GRADED NATURAL GRAVEL OR CRUSHED ROCK HASE, SYZE GODIII SPREAD AND COMPACTED TO 98% OF NAXIMUM DRY DENSITY DETERMINED RY FEYT & URGLE TO BE RES MINISTER OF MINISTER OF CHAFFORM FEY CITY

IANSHIP AND MATERIALS TO BE IN ACCORDANCE WITH A.S.3600 AND THE CONCRETE SPECIFICATION.
2. CONCRETE QUALITY:-

| | | | | |
|----------------|----|------------------------|------|-------------------|
| ELEMENT | | MAX, SIZE AGGREGATE | | CONCRETE GRADE |
| SLAB ON GROUND | EO | 20 | GP : | 32MPa |
| CORE FILL | 60 | 20 | GP | 20MPa |

MIN. CEMENT CONTENT = 270kg/m3 MAX. W/C RATIO = 0.5

- NO ADMIXTURES TO BE USED IN CONCRETE UNITESS APPROVED IN WRITING

- NO ADMIXTURES TO BE USED IN CONCRETE URLESS APPROVED IN WRITING.
 CONCRETE DIMENSIONS SHOWN DO NOT INCLUDE THICKNESSES OF APPLIED FINISHES.
 DEPTHS OF BEARS ARE GIVEN FIRST AND INCLUDE SLAB THICKNESS.
 ALL EXPOSED EDGES AND CORNERS TO BE PROVIDED WITH 25mm FILLETS OR CHARFERS.
 MAINTAIN COVER TO REINFORCEMENT AT THESE DETALS UNLESS OTHERWISE INDICATED.
 NO HOLES, CHASES OR CHREDINENT OF PIPES OTHER THAN THOSE SHOWN ON THE STRUCTURAL
 DRAWINGS TO BE MADE IN CONCRETE MEMBERS WITHOUT THE PRIOR WRITTEN APPROVAL OF THE
- SUPERINTENDENT/DESIGNER.

 8. CONSTRUCTION JOINTS WHERE NOT SHOWN TO BE LOCATED TO THE APPROVAL OF THE
- 8. CONSTRUCTION JOINS WHERE NOT SHOWN TO BE LOCATED TO THE APPROVAL OF THE SUPERINTENDENT /DESIGNER. DETAILS OF CONSTRUCTION JUNTS TO BE SUBMITTED TO THE SUPERINTENDENT /DESIGNER FOR APPROVAL.

 9. THE PHILISHED CONCRETE TO BE A DENSE HONDGENEOUS MASS, COMPLETELY FILLING THE FORMWORK THOROUGHLY PHOREOUND THE REINFRICEMENT AND FREE OF STONE POCKETS. ALL CONCRETE INCLUDING SLABS ON GROUND AND FOOTINGS, TO BE COMPACTED WITH MECHANICAL WERATORS.

 10. CURNO OF ALL CONCRETE TO BE ACHIEVED BY XEPPING SUPPRACES CONTINUOUSLY, WET FOR A PERIOD OF 3 DAYS, AND PREVENTION OF LOSS OF MOISTURE FOR A TOTAL OF 7 DAYS FOLLOWED BY A GRADUAL GRYBING OF THE STRUCTURE OF A CONTRIBUTION OF DAYS AND SE USED UP PROTECTED FROM WIND AND TRAFFIC.

 11. CONSTRUCTION SUPPORT PROPINGE TO BE LEFT IN PLACE WHERE NEEDED TO AVORD OVERSTRESSING THE STRUCTURE DUE TO CONSTRUCTION LEADING.

FORMWORK

FWI CONCRETE FORMED SURFACES TO HAVE THE FOLLOWING FINISHES IN ACCORDANCE WITH ASSETS UNLESS NOTED OTHERWISE ON THE ARCHITECTURAL DRAWINGS OR IN THE ARCHITECTURAL

| EMENT | <u>SPECIFICATION</u> FUNISH | <u>CRITICAL</u> FACE |
|-----------------------|--------------------------------|-------------------------|
| OTING BEAMS, FOOTINGS | CLASS 3 | EXPOSED FACES |
| PERSTRUCTURE SLABS | CLASS 2 | EXPOSED |
| | CLASS 4 | CONCEALED |

REINFORCEMENT
1 CLEAR CONCRETE COVER TO ALL REINFORCEMENT TO BE AS FOLLOWS, UNLESS SHOWN OTHERWISE.

| ELEMENT | COVER(mm) EXPOSED TO SOIL | COVER(com) EXPOSED TO WEATHER |
|---------------------------|------------------------------|-------------------------------|
| FOOTINGS & BASEMENTS SLAB | 50 | 40 |
| | | |
| | | |
| | | |

- ALL REINFORCEMENT TO BE FIRMLY SUPPORTED NOT GREATER THAN In: CENTRES BOTH WAYS, UNLESS NOTED OTHERWISE, BARS TO BE TIED AT ALTERNATE INTERSECTIONS.

- URLESS NOTED THEM THE BARS TO BE TIED AT ALTERNATE INTERSECTIONS.

 REINFORCEMENT SYMBOLS.

 N DENOTES GRADE 400 Y BARS TO A.S. 1302 GRADE Y TEMPCORED.

 R DENOTES GRADE 400 Y BARS TO A.S. 1302 GRADE Y TEMPCORED.

 R DENOTES GRADE 450 R HOT ROLLED PLAIN BARS TO A.S. 1302.

 SL, RL. DENOTES FABRIC TO AS 4611 (BRADE 500)

 F DENOTES GRADE 450 W HARD-DRAWN WIRE REINFORCING FABRIC TO A.S. 1304.

 W DENOTES GRADE 450 W HARD-DRAWN PLAIN WIRE TO A.S. 1303.

- Y (BAR GRADE AND TYPE)

 20 INDMINAL BAR SIZE IN IND)

 25 ISPACING IN COMP

 25 ISPACING IN COMP

 THE FIGURE FOLLOWING THE FABRIC SYMBOL F IS THE REFERENCE NUMBER FOR FABRIC TO A.S.1304.

 4. REINFORCEMENT BARS TO BE LAID IN LAYERS TAGGED ON PLANS AS FOLLOWS:
 8 DENOTES BARS LAID IN BOTTOM LAYER SECOND.

 T DENOTES BARS LAID IN TOP LAYER FIRST.

 TT DENOTES BARS LAID IN TOP LAYER FIRST.

 TT DENOTES BARS LAID IN TOP LAYER LAST.

 5. REINFORCEMENT IS REPRESENTED DIAGRAMMATICALLY AND NOT NECESSARILY IN TRUE PROJECTION.

 6. SPULCES IN REINFORCEMENT TO BE HADD ONLY IN POSITION SHOWN, OR OTHERWISE APPROVED IN WRITING BY THE SUPPERINTENDENT/DESIGNER, MODKS, LAPS, SPLICES AND BENDS TO BE IN ACCORDANCE WITH AS 3600. ACCORDANCE WITH AS 3600. LAPS TO BE NOT LESS THAN THE DEVELOPMENT LENGTH FOR EACH BAR SHOWN BELOW U.N.O.

| BAR SIZE (mm) | SPLICE LENGTH (mm) |
|---------------|--------------------|
| NIZ | 475 |
| N15 | 625 |
| N20 | 800 |
| N24 | 950 |
| NZB | 1250 |
| N32 | 1575 |

- 7. WELDING OF REINFORCEMENT NOT TO BE PERMITTED UNLESS SHOWN ON THE STRUCTURAL
- DRAWINGS OR APPROVED BY THE SUPERINTENDENT/DESIGNER.

 8. JOGGLES TO BARS TO BE 1 BAR DIAMETER OVER A LENGTH OF 12 BAR DIAMETERS UNLESS
- FABRIC TO BE LAPPED Z TRANSVERSE WIRES PLUS SOMM, BUNDLED BARS TO BE TIED TOGETHER

- 1 ALL BRICKS SHALL HAVE MINIMUM COMPRESSIVE STRENGTH OF ZOMPA
- 2. BRICKWORK MORTAR MIX SHALL BE 1:1:6 OR 1:0.5:4.5
- BRICKWORK SURFACES SUPPORTING CONCRETE SHALL BE TROWELLED SHOOTH & COVERED WITH 0.65mm ALUNINUM CORE BITUM HOUS STRIP OR EQUIVALENT TO PREVENT BONDING OF CONCRETE TO BRICKWORK.
- ALL CORES SHALL BE FILLED WITH GROUT HAVING A NORMAL COMPOSITION OF 1 PART CEMENT, 3 PARTS SAND AND 2 PARTS 10mm COARSE AGGREGATE. THE GROUT SHALL HAVE A SLUMP OF 230mm AND COMPRESSIVE STRENGTH F'c = 20 MPa
- THE GROUT SHALL HAVE A SLUPP OF ZBORD AND COMPRESSIVE STRENGTH FC = 20 MPB WALLS TO BE FULL HEIGHT OF EACH LIFT BEFORE GROUTING CORES, CLEANOUT OPENINGS TO BE PROVIDED AT BOTTOM COURSE IN ALL CORES OF EACH LIFT.

 MORTAR JOINTS TO BE TODLED AT EXPOSED OR RENDERED SURFACES.


 BEFORE PLACING VERTICAL REINFORCEMENT, CORES ARE TO BE CLEANED OF ALL MORTAR FINS AND DROPPINGS THROUGH CLEANOUT OPENINGS WHICH ARE NOT TO BE CLOSED UNTIL INSPECTED BY SUPERINFERDENT/FINGERER.

 GROUT TO BE RODDED TO ENSURE FILLING OF CORES WITH A MAXIMUM CONTINUOUS POUR RESIDENCE AREADS.

MISCELLANEOUS

1. NO PENETRATIONS OR CHASES SHALL BE MADE IN MASONRY WALLS OR OTHER STRUCTURE WITHOUT APPROVAL OF THE STRUCTURAL ENGINEER.

| A - | | | | Ţ | _ | | | - | Ţ: | GENERAL NOTES: | | | | QUALI | | APPROVED: | CUENT: | | me | DRAWING STATUS | ISSUED FOR CONSTR | A |
|----------|--------------|-------------------------|-----|-----------------|----|--|----------|-------|-------|--|------------------------|---|-------------------------------|---------------|----------------------------------|-------------------------------------|--|-----|---------------|------------------|-------------------------|-----------------------|
| | ISSUFD |) FOR CONSTRUCTION | ARS | 02.06.1 | 17 | | | | | Des GRESCO à DOS CHARGES CA SECUCIOS CONSTITUTO CON CA SAL-18 PER REALINEAU, 2017. NO DE CORP. CONSTITUTION DE 2 E est allabor 10 cm on repressor d'un compart au et rom con pour et a Salvada soutre d'exployed actual de l'actual 2007 de SAL-180 CHARGE, DEL TEXTO MONDON ART TO CE CONCERN CONTRACTO SI SURVI DE CONTRA L'ACTUAL DE CONTRACTOR DE CONTRACTOR DE ACOUNTIES SI SURVI DE CONTRACTOR DE CONTRACTOR DE CONTRACTOR DE ACOUNTIES SI SURVI DE CONTRACTOR DE CONTRACTOR DE CONTRACTOR DE ACOUNTIES SI CONTRACTOR DE CONTRACTOR DE CONTRACTOR DE CONTRACTOR DE ACOUNTIES SI CONTRACTOR DE CONTRACTOR DE CONTRACTOR DE CONTRACTOR DE ACOUNTIES SI CONTRACTOR DE CONTRACTOR DE CONTRACTOR DE CONTRACTOR DE ACOUNTIES SI CONTRACTOR DE CONTRACTOR DE CONTRACTOR DE CONTRACTOR DE ACOUNTIES SI CONTRACTOR DE CONTRACTOR DE CONTRACTOR DE CONTRACTOR DE ACOUNTIES SI CONTRACTOR DE CONTRACTOR DE CONTRACTOR DE CONTRACTOR DE ACOUNTIES SI CONTRACTOR DE CONTRACTOR DE CONTRACTOR DE CONTRACTOR DE ACOUNTIES SI CONTRACTOR DE CONTRACTOR DE CONTRACTOR DE CONTRACTOR DE CONTRACTOR DE CONTRACTOR DE CONTRACTOR DE ACOUNTIES SI CONTRACTOR DE CO | STA KIN DE PURCE EL | NASTASI & ASS L CONSULTING CIVIL & STRUCT B.E., M.LE. AUST, CP ASH 95 327 2508 LNET S. INVITALIA FRACE, PROTIONS/NOW THE PH. 1529 0507 2814 OF 822 8716 1517 FAX: 622 8731 2811 625: 6411 561 452 | TURAL ENGINEERS ING NPER-3 | DESIGNED Z.D. | 04.05.2017 DATE 04.05.2017 | -Stant | PROJECT: . PROPOSED NEW WAR MEMORIAL S | | GENERAL NOTES | SCALE (AT CROSS | AL SIZE) DRANING NO. | AS NOTED REVISION NO. |
| <u> </u> | | UNARY ISSUE REVISION | BRS | 04.05.1 DATE | 17 | SISSUE | REVISION | BY DA | STATU | 1 . | | ESG. 9412 GAT AGA | | CHECKED | CATE | B. HAETAS BE, W.I.E. AUST, CPENS | McQUADE PARK, 361 GEORGE STRI WINDSOR | ET, | | 9894 | S01.00 | В |
| A1 | | 1 | - | | | <u>, </u> | 2 | | | 3 | | 4 | | 5 | | | 6 | | 7 | | 8 | |

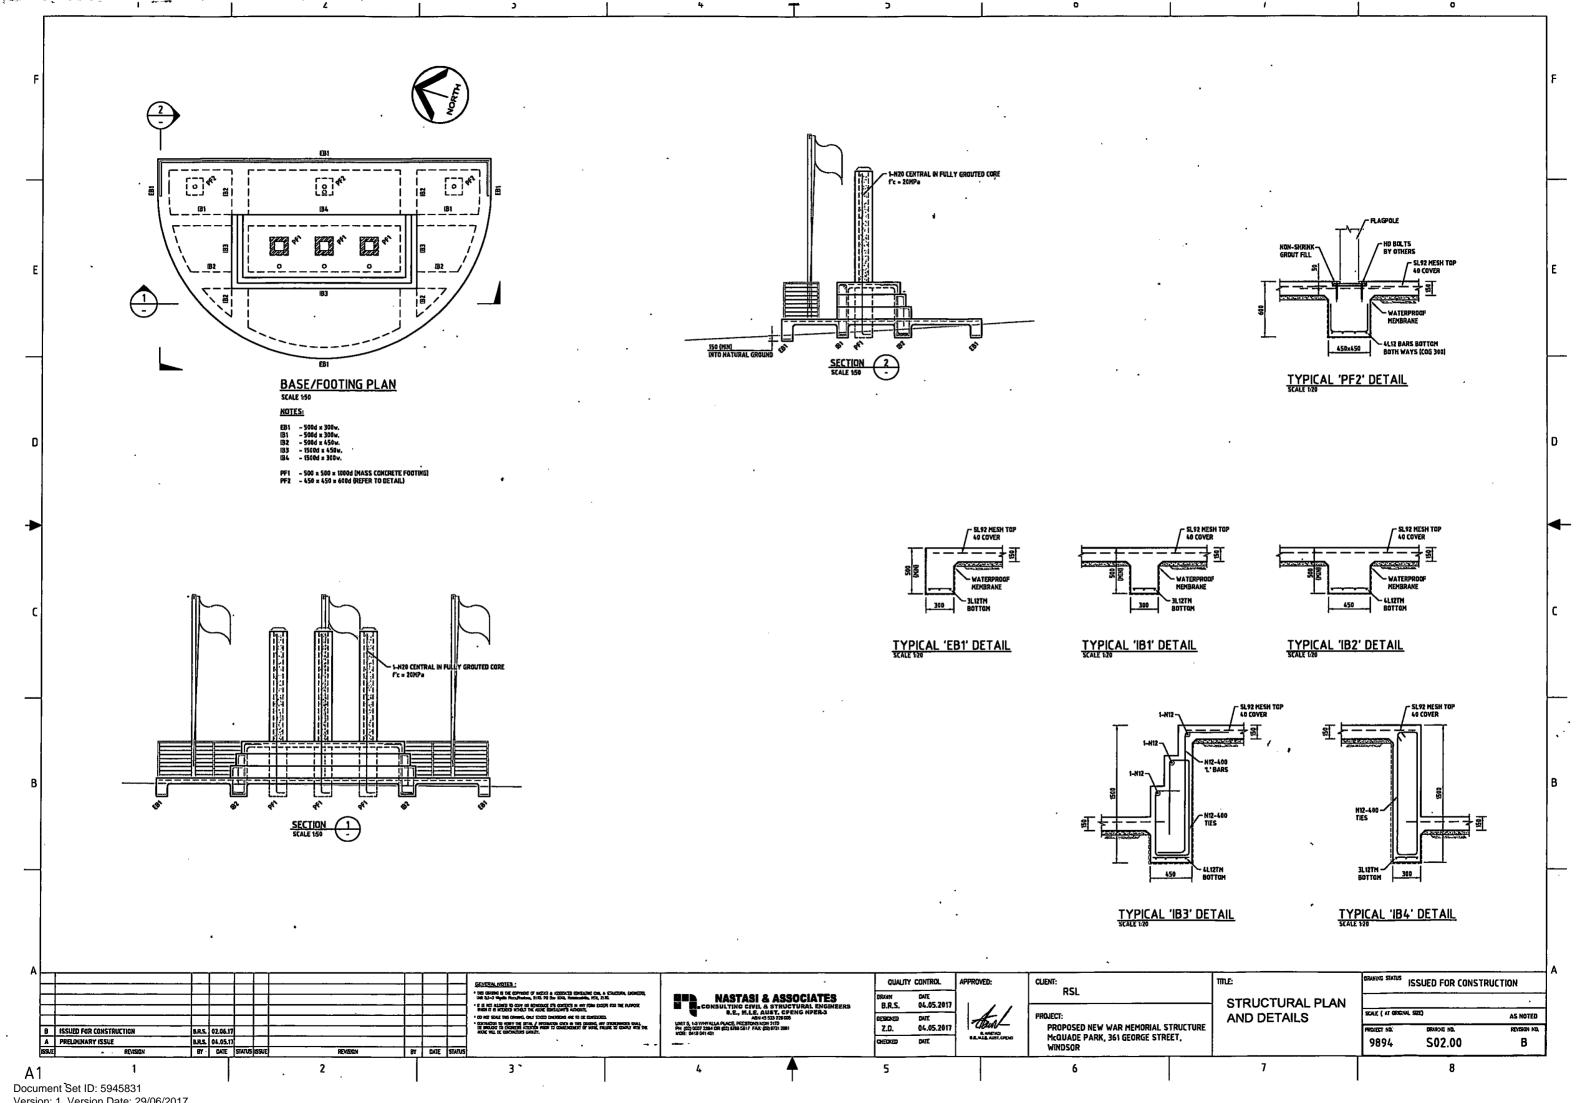

Version: 1, Version Date: 29/06/2017