


## Attachment 1 to Item 12


## **Proposed Plans**

Date of meeting: 20 October 2022

Location: By audio-visual link

Time: 10:00 a.m.

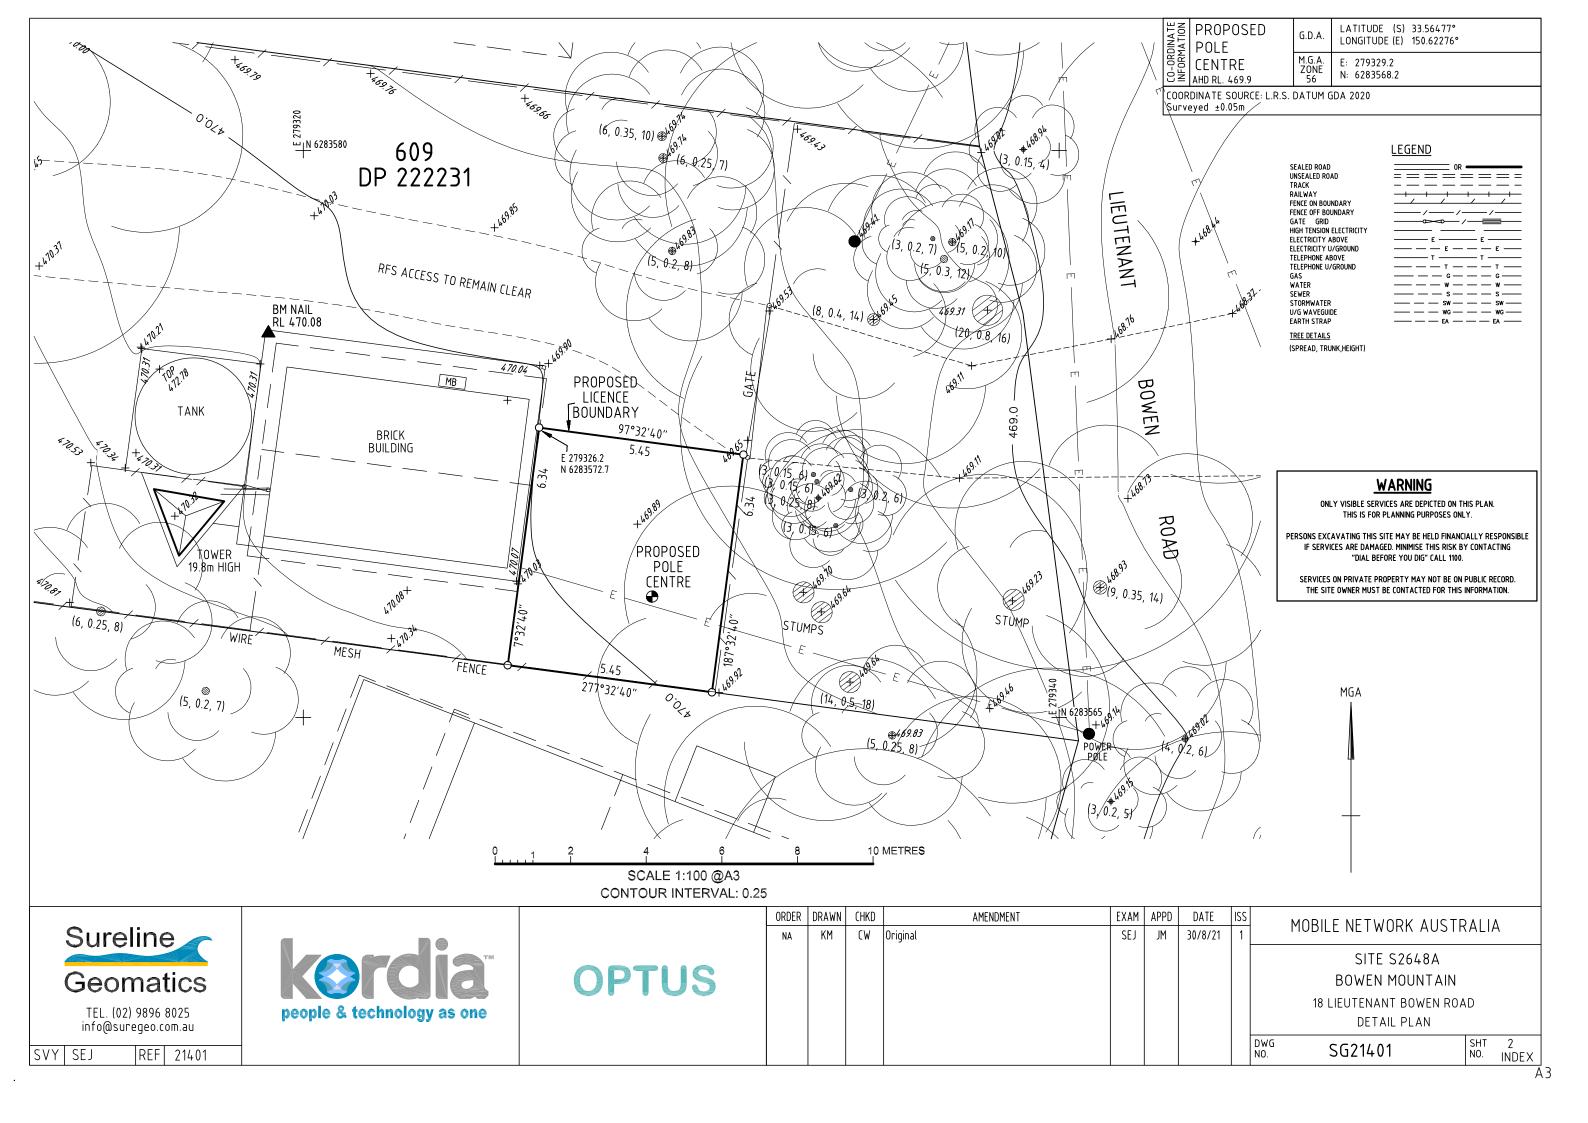

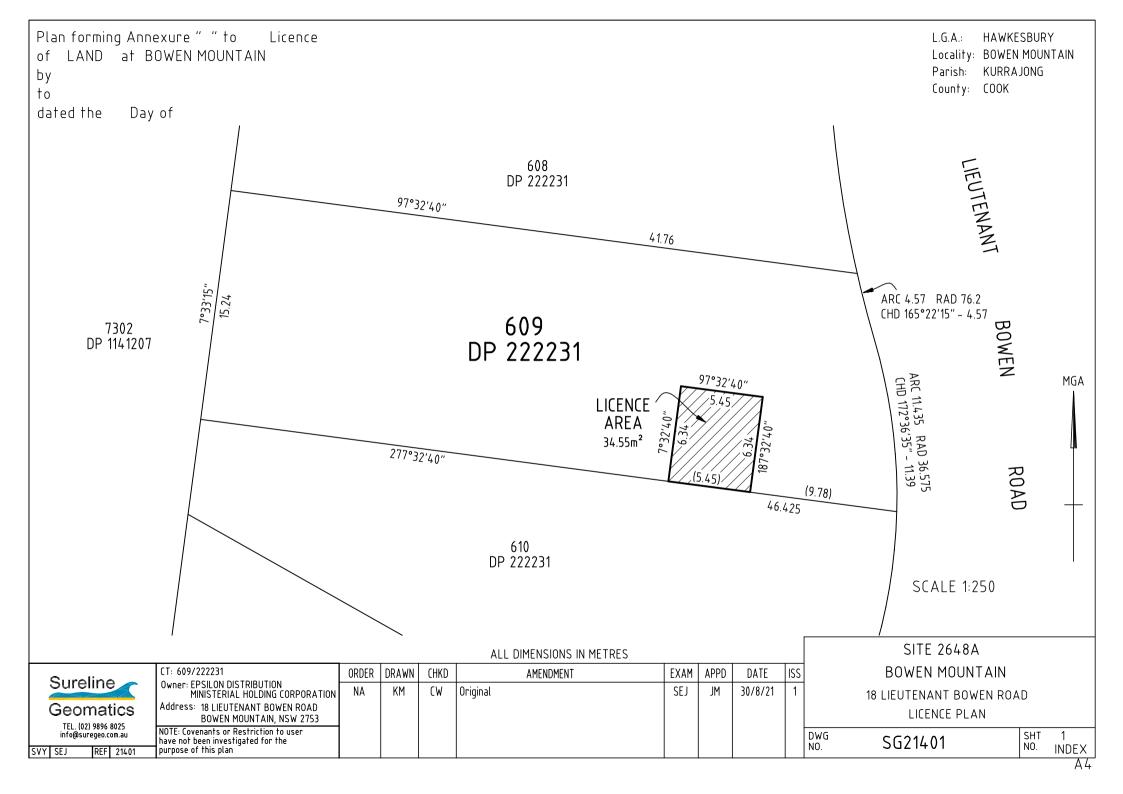



PROPOSED OPTUS
BASE STATION



LOCALITY MAP

COPYRIGHT • - GOOGLE MAPS

EXISTING POWER POLE (POLE ID: 436238) PROPOSED OPTUS U/G POWER ROUTE (TBA) EXISTING PRIVATE POWER - POLE (POLE ID: D436249) EXISTING PROPER BOUNDARY (TYP.) PROPOSED OPTUS INSTALLATION EXISTING ENDEAVOUR ENERGY COMPOUND PROPOSED EWP / CRANE PARKING LOCATION EXISTING O/H POWER LINE EXISTING TREES (TYP. EXISTING FENCE (TYP EXISTING BUILDINGS (TYP.

ORAIRI

OVERALL SITE PLAN

SCALE 1:500

Level 9, 5 Rider Boulevard, Rhodes, NSW 2138
T +612 9856 2600 | www.kordia.com.au


**OPTUS** 

MOBILE NETWORK
AUSTRALIA
SITE No:- S2648A
BOWEN MOUNTAIN
18 LIEUTENANT BOWEN ROAD

DRAFT SITE LAYOUT-SHEET 1 OF 2

 Drawing Status:
 Drawing No.
 Revision O2

 20
 10
 0
 10
 20
 30
 40
 50mm
 40

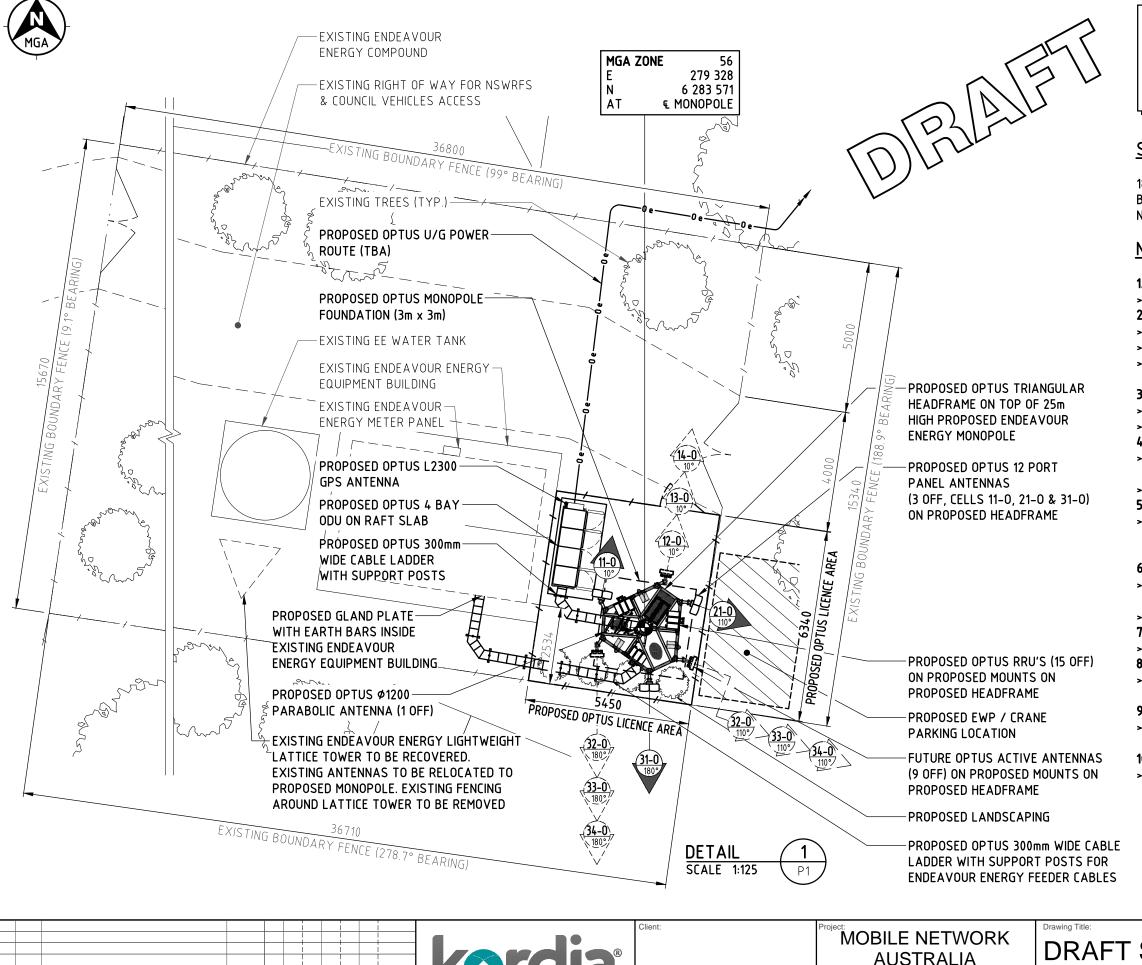

**OPTUS** 

SITE No:- S2648A BOWEN MOUNTAIN

18 LIEUTENANT BOWEN ROAD

| NOTES:

- THIS DRAWING IS DIAGRAMMATIC ONLY
  AND SHOULD NOT BE SCALED.
- 2. DIMENSIONS, COORDINATES AND LEVELS SHOWN ARE NOMINAL AND SUBJECT TO CONFIRMATION BY SURVEYOR.

## SITE ADDRESS:

18 LIEUTENANT BOWEN ROAD BOWEN MOUNTAIN NSW 2753

## NOTES:

- 1. BASIS OF DESIGN
- > SITE INSPECTION 23/04/2020
- 2. PANEL ANTENNAS
- > 1 OFF PER SECTOR (EACH MAX. 2.69m LONG) AT EL 26.00m
- > SECTOR 1 10°, SECTOR 2 110°, SECTOR 3 180°
- > MOUNTED ON PROPOSED OPTUS TRIANGULAR HEADFRAME
- 3. TRANSMISSION
- > PROPOSED OPTUS Ø1200 PARABOLIC ANTENNA AT 22m
- AZIMUTH : TBA
- 4. OPTUS SHELTER
- PROPOSED OPTUS ICS 4 BAY THERMOCAB ODU, COLOURED "PALE EUCALYPT"
- > SUPPORTED ON RAFT SLAB
- 5. ENDEAVOUR ENERGY TOWER
- PROPOSED ENDEAVOUR ENERGY 25m HIGH MONOPOLE WITH PROPOSED OPTUS TRIANGULAR HEADFRAME ON TOP OF MONOPOLE
- 6. FEEDER CABLES
- > SIZE: HYBRID TRUNK CABLES (MLEH 9/18") (1 OFF PER SECTOR)
- > LENGTH: 30m ALL SECTORS
- 7. SITE ACCESS
- > VIA BY LIEUTENANT BOWEN ROAD
- 8. ANTENNA ACCESS
- ANTENNA MAINTENANCE ACCESS ARRANGEMENTS VIA "CHERRY-PICKER" ONLY
- 9. POWER SUPPLY
- > PROPOSED SEPARATE 3 PHASE 63A SUPPLY TO BE ACHIEVED FROM THE EXISTING POWER POLE FOR OPTUS
- 10. OTHER (PAINTING, LANDSCAPING, SCREENING)
- > TBA

DRAFT SITE LAYOUT -SHEET 2 OF 2

Drawing Status:
FOR APPROVAL

Drawing No. S2648A-P2 02

10 0 10 20 30 40 50mm A

KORDIA | SM | FA |

KORDIA TN XX!

FA i

XX !

JB

XX!

T +61 2 9856 2600 | www.kordia.com.au

02 07.04.21 ISSUED FOR APPROVAL

01 14.09.20 ISSUED FOR APPROVAL

